

OWNER / APPLICANT

TRANSCONTINENTAL GAS PIPE LINE COMPANY, LLC.
(TRANSCO)
P.O. BOX 1396
2800 POST OAK BLVD.
HOUSTON, TX 77056

CONTACT: KAREN OLSON
PERMIT AGENT
(713) 215-4232

PLAN PREPARER

AECOM
625 WEST RIDGE PIKE, SUITE E-100
CONSHOHOCKEN, PA 19428

CONTACT: PETER HAAS, P.E.
PROJECT ENGINEER
(610) 832-8832

CERTIFYING ENGINEER: KEVIN MCKEON, P.E.

PROJECT DESCRIPTION

TRANSCONTINENTAL GAS PIPE LINE COMPANY, LLC (TRANSCO) IS PROPOSING TO CONSTRUCT ITS COMPRESSOR STATION (CS 206) IN FRANKLIN TOWNSHIP, SOMERSET COUNTY, NEW JERSEY. THE PROJECT WILL INVOLVE THE CONSTRUCTION OF SMALL BUILDINGS, GRAVEL ACCESS ROAD AND PARKING AREAS, EQUIPMENT PADS, AND THE INSTALLATION OF TWO GAS PIPELINES (A SUCTION LINE AND A GAS DISCHARGE LINE) TO CONNECT THE PROPOSED COMPRESSOR STATION TO THE EXISTING NATURAL GAS TRANSMISSION LINE.

THESE DRAWINGS SHOW THE SITE GRADING AND POST CONSTRUCTION STORMWATER MANAGEMENT MEASURES PLANNED IN CONJUNCTION WITH CS206, IN ACCORDANCE WITH N.J.A.C. 7:8 (STORMWATER MANAGEMENT) SUBCHAPTER 5.


THIS EXPANSION PROJECT IS REGULATED BY THE U.S. DEPARTMENT OF ENERGY, FEDERAL ENERGY REGULATORY COMMISSION (FERC). IN ADDITION TO STATE AND LOCAL REQUIREMENTS, THIS EROSION AND SEDIMENT CONTROL PLAN INCLUDES MITIGATION MEASURES FOR PIPELINE CONSTRUCTION SPECIFIED BY FERC IN ITS PLAN AND PROCEDURES DOCUMENTS, UP LAND EROSION CONTROL, REVEGETATION AND MAINTENANCE PLAN, MAY 2013 AND WETLAND AND WATERBODY CONSTRUCTION AND MITIGATION PROCEDURES, MAY 2013.

ANTICIPATED CONSTRUCTION & RESTORATION SCHEDULE

	START	END
CONSTRUCTION	SPRING 2020	SPRING 2021
RESTORATION	SPRING 2021	FALL 2021

POST CONSTRUCTION STORMWATER MANAGEMENT PLAN (PCSM) NORTHEAST SUPPLY ENHANCEMENT PROJECT COMPRESSOR STATION NO. 206 TRAP ROCK ACCESS ROAD FRANKLIN TOWNSHIP, SOMERSET COUNTY, NEW JERSEY


SHEET INDEX	
DESCRIPTION	SHEET NUMBER
COVER SHEET	1
EXISTING CONDITIONS AND SOILS MAP (SHEET 1 OF 3)	2
EXISTING CONDITIONS AND SOILS MAP (SHEET 2 OF 3)	3
EXISTING CONDITIONS AND SOILS MAP (SHEET 3 OF 3)	4
POST CONSTRUCTION STORMWATER MANAGEMENT PLAN (SHEET 1 OF 3)	5
POST CONSTRUCTION STORMWATER MANAGEMENT PLAN (SHEET 2 OF 3)	6
POST CONSTRUCTION STORMWATER MANAGEMENT PLAN (SHEET 3 OF 3)	7
DETAILS (SHEET 1 OF 4)	8
DETAILS (SHEET 2 OF 4)	9
DETAILS (SHEET 3 OF 4)	10
DETAILS (SHEET 4 OF 4)	11
INFILTRATION BASIN PROFILE PLAN	12
DETENTION BASINS PROFILE PLAN	13

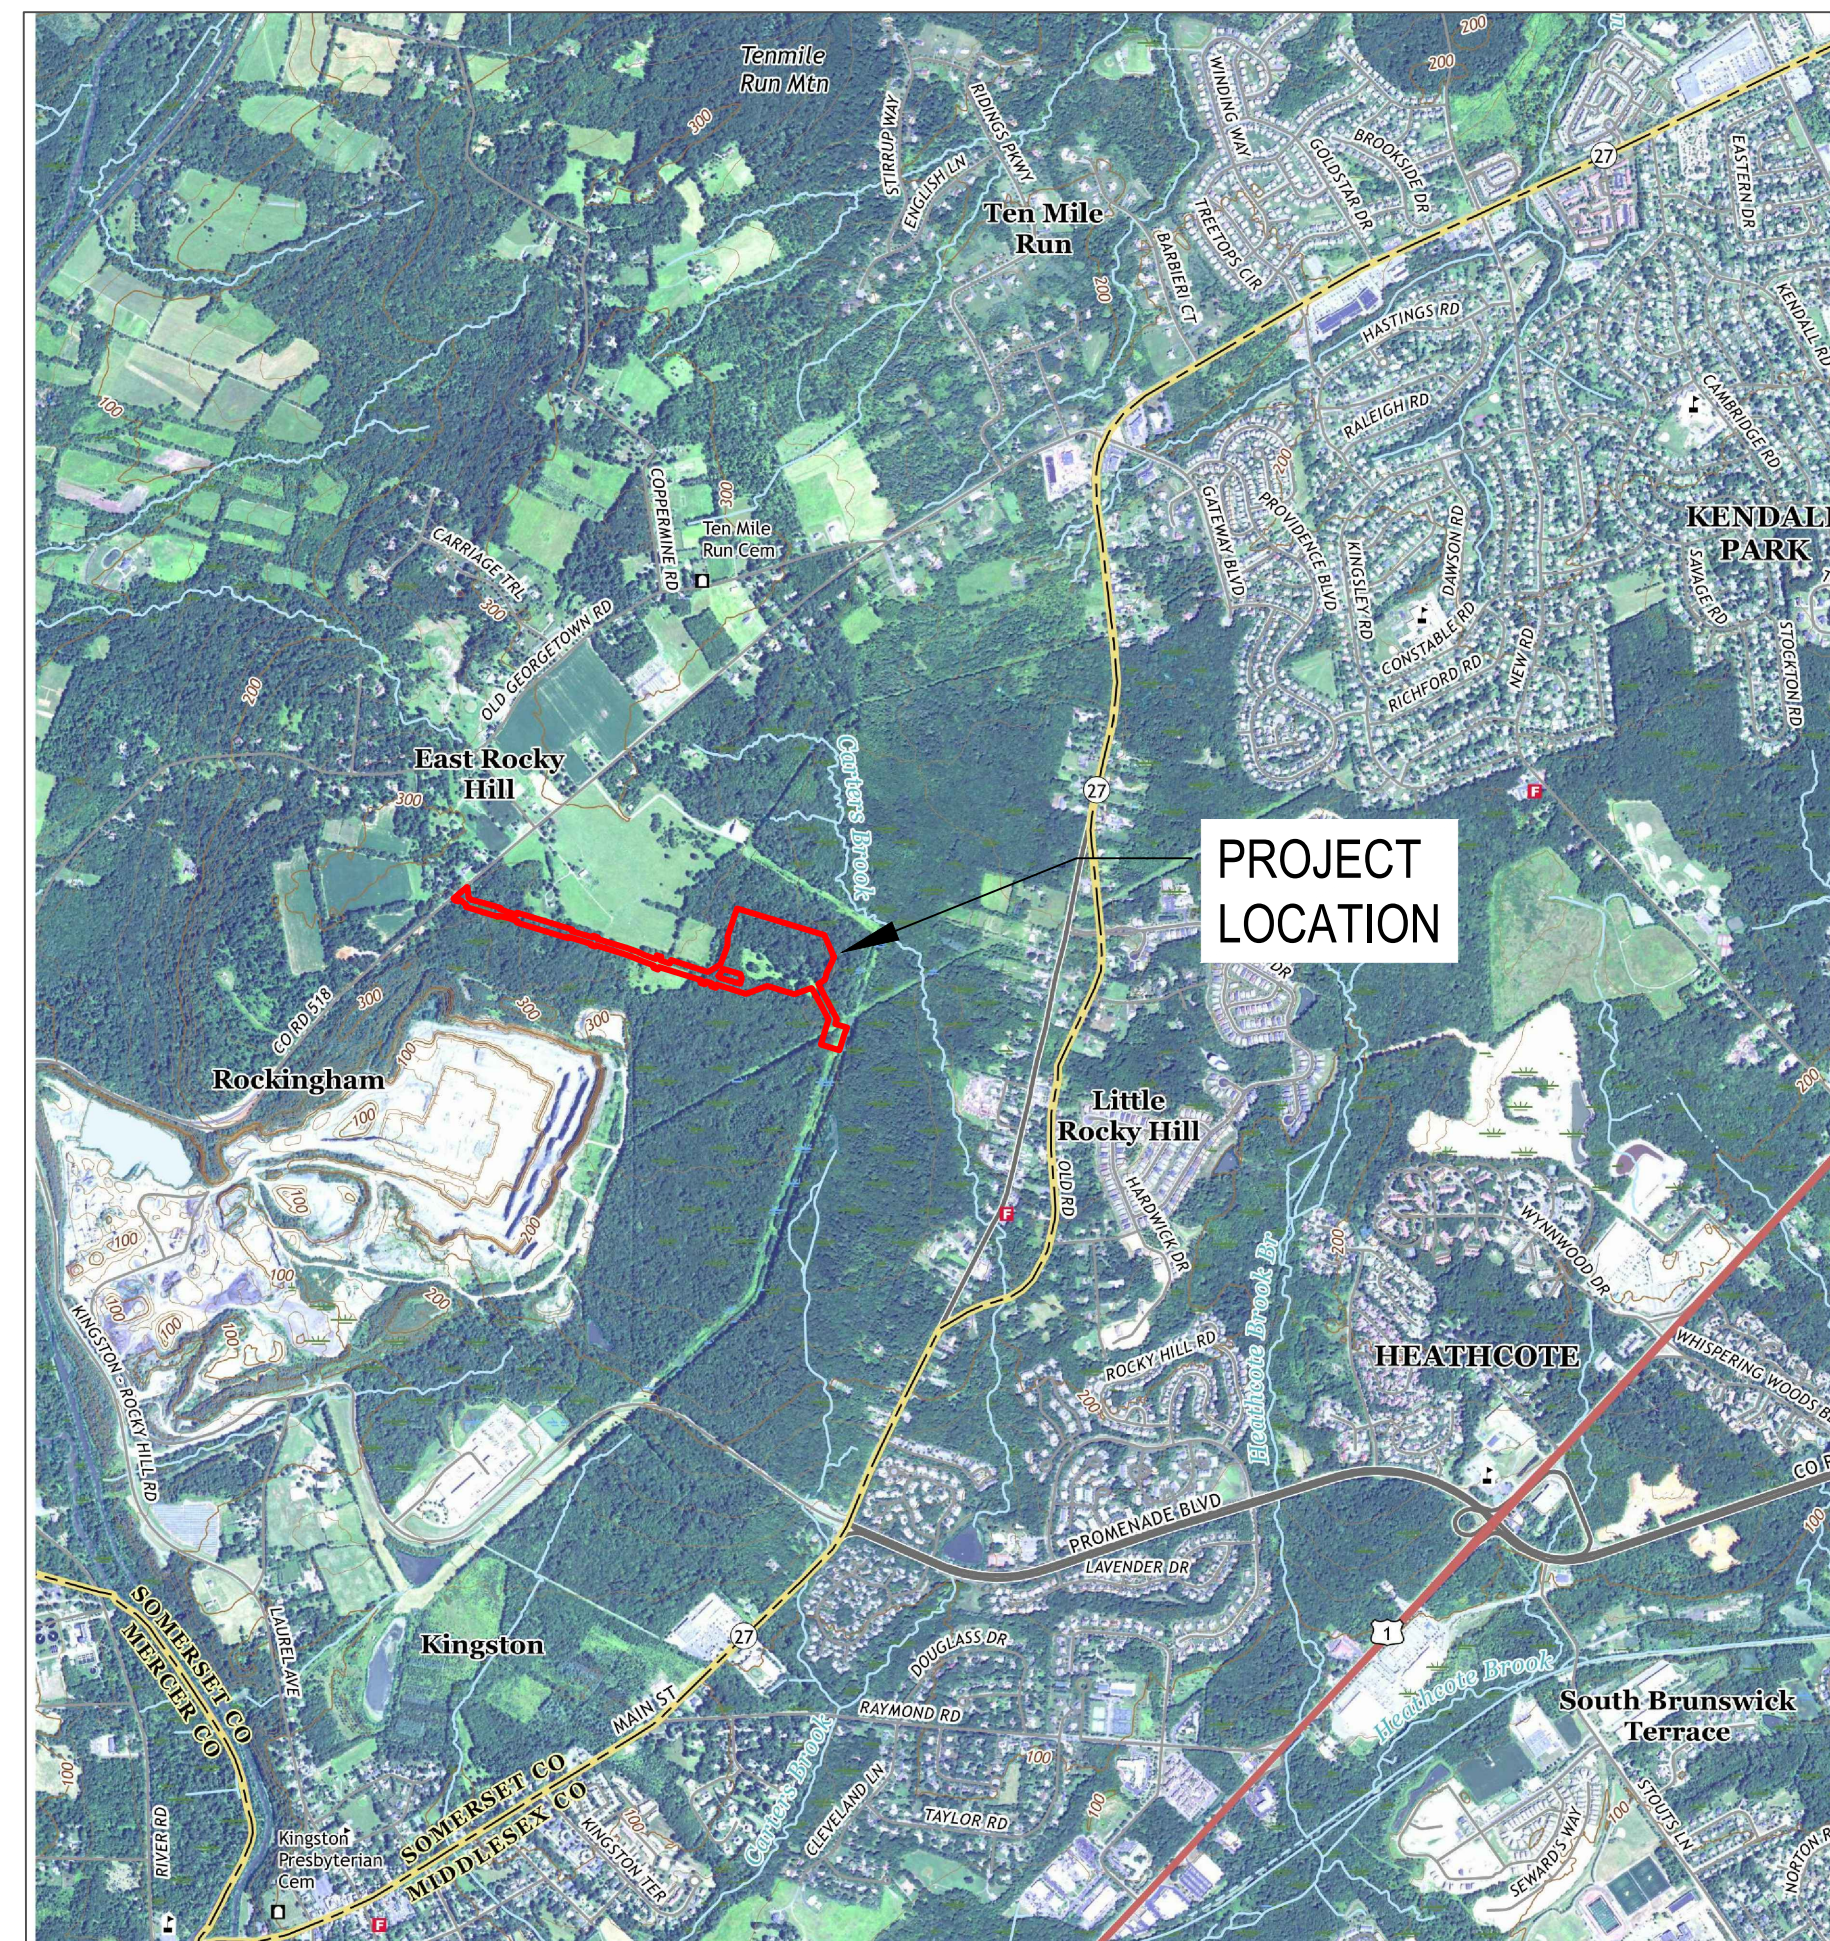


USGS AERIAL MAP



MAP SOURCE
MONMOUTH JUNCTION, NJ QUADRANGLE
U.S. GEOLOGICAL SURVEY, 2016

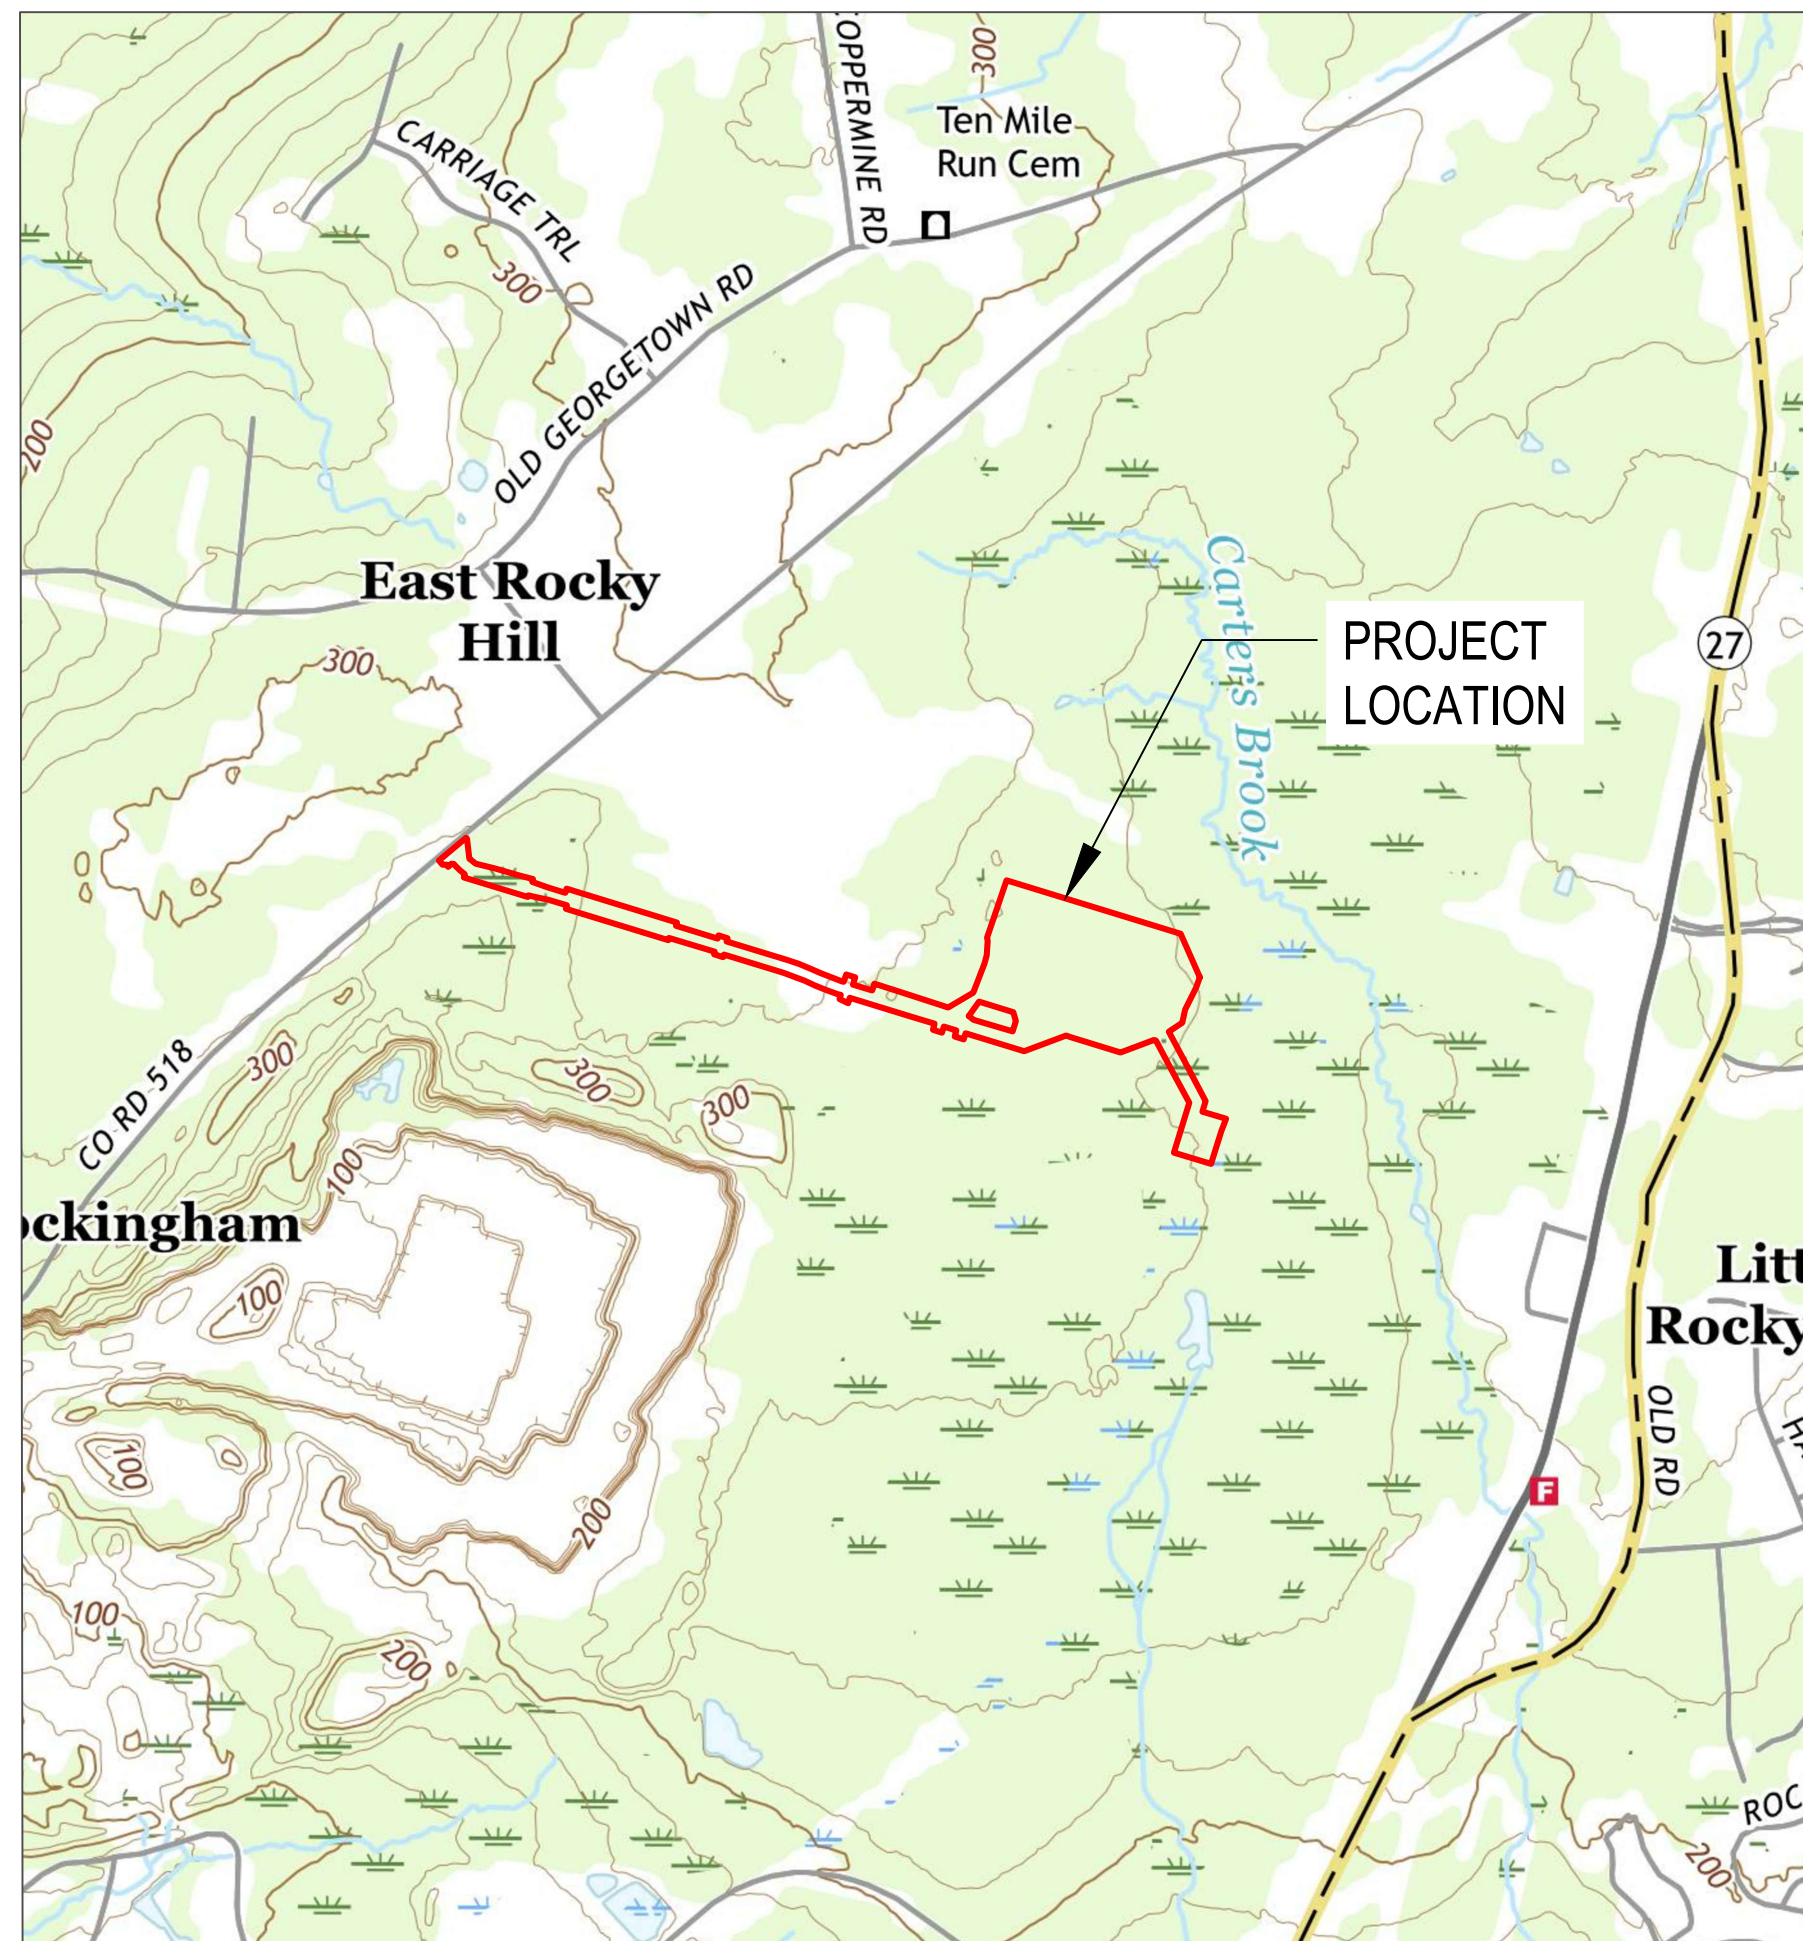


USGS TOPOGRAPHIC MAP

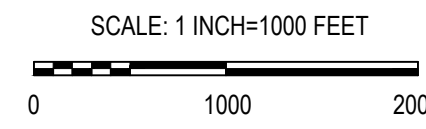

MAP SOURCE
MONMOUTH JUNCTION, NJ QUADRANGLE
U.S. GEOLOGICAL SURVEY, 2016

BMP INDEX	
DESCRIPTION	SHEET NUMBER
INFILTRATION BASIN	8
CONCRETE OUTLET-STRUCTURE (INFILTRATION BASIN)	8
BRUSH SEEDING	8
TRASH RACK	8
DETENTION BASIN	9
CONCRETE OUTLET-STRUCTURE (DETENTION BASIN)	9
PIPE BEDDING	9
TRASH RACK	9
TYPE DW ENDWALL	10
CULVERT FOR NON-STREAM CROSSING	10
RIPRAP APRON	10
CONCRETE ANTI-SEEP COLLAR	10
VEGETATED CHANNEL	11
RIPRAP CHANNEL	11
RIPRAP SLOPE PROTECTION	11
CULVERT FOR STREAM CROSSING	11
REINFORCED GRAVEL ACCESS ROAD	11

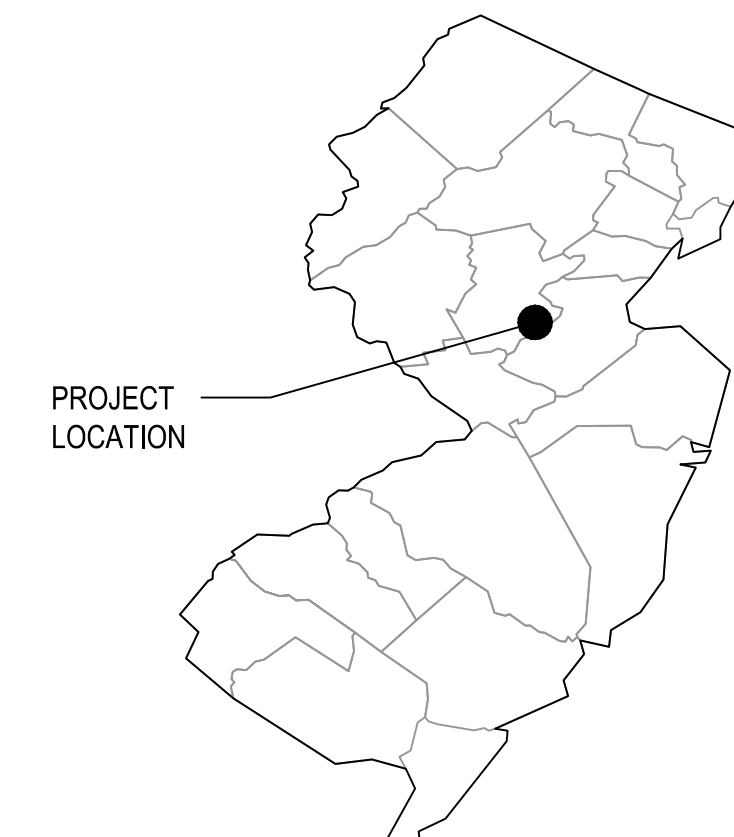

STATE OF NEW JERSEY

SEQUENCE OF CONSTRUCTION

- ALL EARTH DISTURBANCES, INCLUDING CLEARING AND GRUBBING AS WELL AS CUTS AND FILLS SHALL BE DONE IN ACCORDANCE WITH THE APPROVED SE&SC PLAN. A COPY OF THE APPROVED DRAWINGS (STAMPED, SIGNED AND DATED BY THE REVIEWING AGENCY) MUST BE AVAILABLE AT THE PROJECT SITE AT ALL TIMES. THE REVIEWING AGENCY SHALL BE NOTIFIED OF ANY CHANGES TO THE APPROVED PLAN PRIOR TO IMPLEMENTATION OF THOSE CHANGES. THE REVIEWING AGENCY MAY REQUIRE A WRITTEN SUBMITTAL OF THOSE CHANGES FOR REVIEW AND APPROVAL AT ITS DISCRETION.
- AT LEAST SEVEN (7) DAYS PRIOR TO STARTING ANY EARTH DISTURBANCE ACTIVITIES, INCLUDING CLEARING AND GRUBBING, THE OWNER AND/OR OPERATOR SHALL INVITE ALL CONTRACTORS, THE LANDOWNER, APPROPRIATE MUNICIPAL OFFICIALS, THE SE&SC PLAN PREPARER, THE PCSM PLAN PREPARER, THE LICENSED PROFESSIONAL RESPONSIBLE FOR OVERSIGHT OF CRITICAL STAGES OF IMPLEMENTATION OF THE PCSM PLAN, AND A REPRESENTATIVE FROM THE LOCAL CONSERVATION DISTRICT TO AN ON-SITE PRE-CONSTRUCTION MEETING.
- MAKE NOTIFICATIONS ACCORDING TO PERMIT REQUIREMENTS.
- HOLD PRE-CONSTRUCTION MEETING WITH ENVIRONMENTAL INSPECTOR.
- INSTALL STABILIZED CONSTRUCTION ENTRANCES AND OTHER TEMPORARY PERIMETER EROSION CONTROL MEASURES (I.E. SEDIMENT BARRIER) AS INDICATED ON THE SE&SC PLANS AND DETAILS PRIOR TO EARTH DISTURBING ACTIVITIES.
- CONSTRUCT THE SEDIMENT BASIN, INCLUDING OUTLET STRUCTURE, OUTLET PROTECTION AND EMERGENCY SPILLWAY AS INDICATED ON THE SE&SC PLANS AND DETAILS. CARE SHOULD BE TAKEN TO AVOID COMPACTION OF THE BASIN BOTTOM. REFER TO THE 'BASIN COMPACTION NOTES'. DO NOT INSTALL THE SAND MEDIA IN THE BASIN BOTTOM AT THIS TIME.

- REMOVE TOPSOIL FROM VEGETATED AREAS TO BE DISTURBED DURING EXCAVATION AND STOCKPILE IN STOCKPILE AREA.
- COMPLETE WORK ACTIVITIES ASSOCIATED WITH CONSTRUCTION OF COMPRESSOR STATION, ACCESS ROAD, LOOP ROAD, VALVES AND PIPING, VEGETATED SWALES ETC.
- RETURN TOPSOIL TO DESIGNATED AREAS.
- COMPLETE FINAL STABILIZATION INCLUDING SOIL TREATMENT, SEEDBED PREPARATION, SEED APPLICATION AND MULCHING.
- AFTER FINAL STABILIZATION IS COMPLETED BY REVEGETATION AND OTHER PERMANENT STABILIZATION MEASURES, AS APPLICABLE, CONSTRUCT DETENTION BASINS #1 AND #2. CLEAN OUT THE SEDIMENT BASIN AND CONVERT TO AN INFILTRATION BASIN BY INSTALLING SAND MEDIA IN THE BASIN BOTTOM.
- REMOVE ALL TEMPORARY SOIL EROSION AND SEDIMENT CONTROLS AND CLEAN UP PROJECT SITE.
- SUBMIT A COMPLETED NOTICE OF TERMINATION TO THE CONSERVATION DISTRICT.

MAINTENANCE

ALL SOIL EROSION AND SEDIMENT CONTROL MEASURES SHALL BE CHECKED DAILY AND AFTER EACH SIGNIFICANT RAINFALL. THE SEDIMENT BARRIER SHALL BE CHECKED REGULARLY FOR UNDERMINING, AND DETERIORATION OF THE FABRIC. SEDIMENT SHALL BE REMOVED WHEN THE LEVEL OF SEDIMENT DEPOSITION IS HALF WAY TO THE TOP OF THE BARRIER. THE SEEDING AREAS SHALL BE CHECKED TO ENSURE THAT THE DEVELOPMENT OF A GOOD VEGETATIVE STAND AND GROWTH CONTINUES. THE AREAS SHALL BE FERTILIZED AND RESEED AS NEEDED.


DISTURBED AREA	
AREA DESCRIPTION	ACREAGE
COMPRESSOR STATION 206	25.0 ACRES

REFERENCES

- EXISTING FEATURE INFORMATION (TOPOGRAPHY, PROPERTY LINES, UTILITIES, ETC.) BASED ON FIELD SURVEY PROVIDED BY TRANSCONTINENTAL GAS PIPE LINE COMPANY, LLC (TRANSCO)
- STREAM AND WETLAND INFORMATION SHOWN BASED ON FIELD DELINEATION PERFORMED BY ECOLOGY & ENVIRONMENT AND PROVIDED BY TRANSCONTINENTAL GAS PIPE LINE COMPANY, LLC (TRANSCO).
- PROPOSED SITE LAYOUT INFORMATION (ROADWAY, COMPRESSOR STATION FACILITIES, GRADING, ETC.) PROVIDED BY HUNT GUILLOT & ASSOCIATES (HGA).

KEVIN MCKEON, P.E. 625 WEST RIDGE PIKE, SUITE E-100 CONSHOHOCKEN, PA 19428 (610) 832-3500	REVISIONS	TRANSCONTINENTAL GAS PIPE LINE COMPANY, LLC. POST CONSTRUCTION STORMWATER MANAGEMENT PLAN NORTHEAST SUPPLY ENHANCEMENT PROJECT COMPRESSOR STATION NO. 206 - TRAP ROCK ACCESS ROAD COVER SHEET FRANKLIN TOWNSHIP, SOMERSET COUNTY, NJ																																																																																																						
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LEGEND

EXISTING FEATURES		PROPOSED FEATURES	
	265 EXISTING MAJOR CONTOUR		L00 LIMIT OF DISTURBANCE
	EXISTING MINOR CONTOUR		
	STREAM CENTERLINE		
	WETLAND		
	PARCEL LINE		
	EXISTING ACCESS ROADS		
	EXISTING FENCE		
	EXISTING OVERHEAD POWER LINE		
	EXISTING PIPELINE		
	EXISTING RIGHT OF WAY		
	SOIL TYPE BOUNDARY		
	SOIL TYPE		

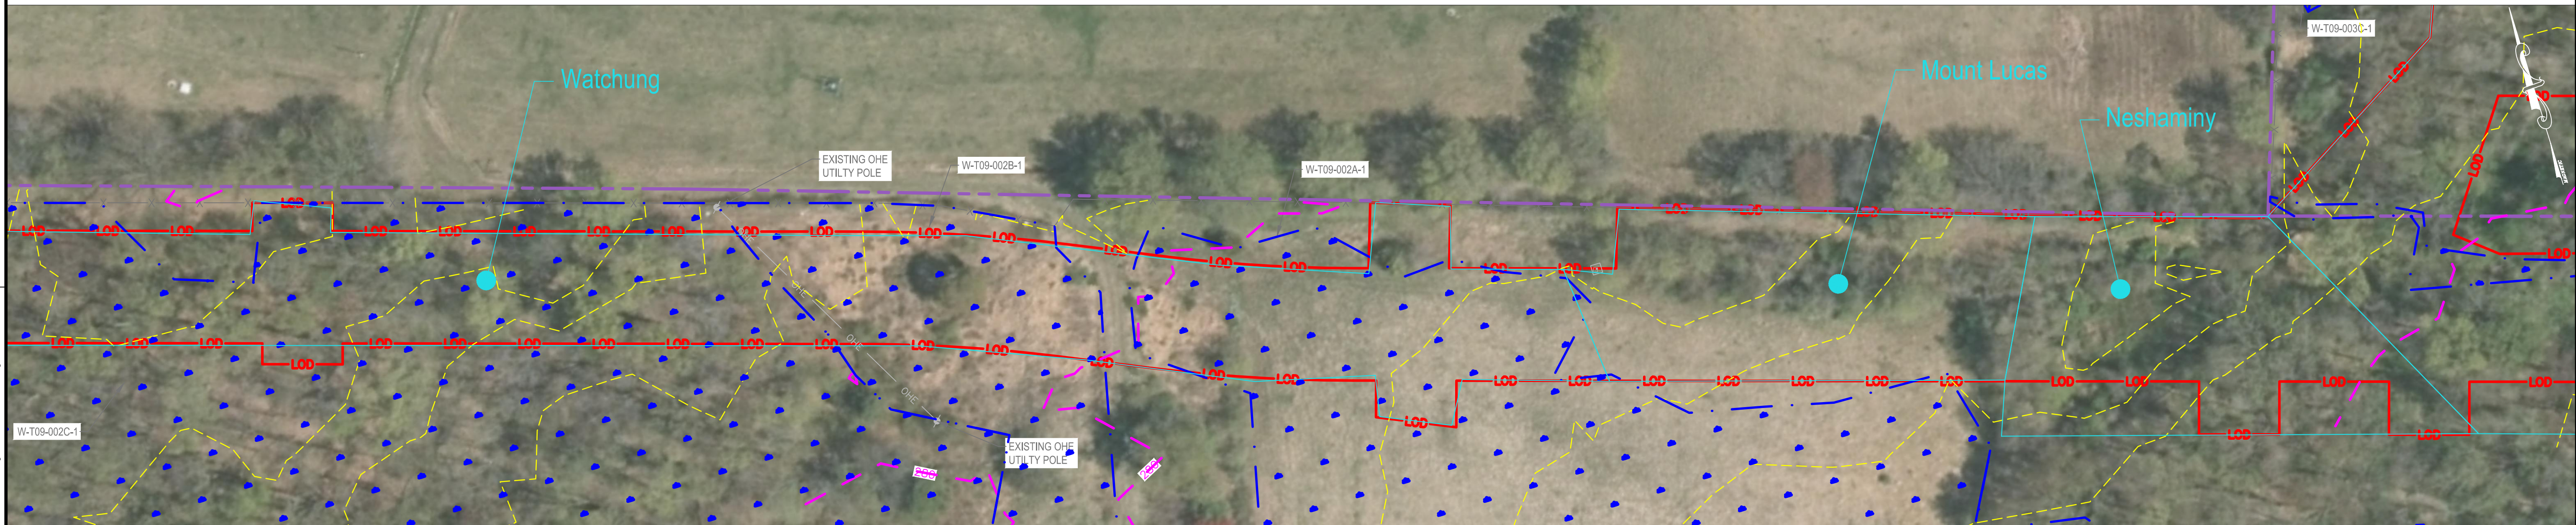NOTES

- THIS BASE MAP WAS PREPARED ON AERIAL TOPOGRAPHY AND ACTUAL FIELD SURVEY PROVIDED BY WILLIAMS AND ARE REFERENCED TO THE NEW JERSEY STATE PLANE DATUM.
- PROPERTY LINE INFORMATION PROVIDED BY WILLIAMS.
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SOIL LEGEND

MtA MOUNT LUCAS SILT LOAMS
 NshB NESHAMINY SILT LOAMS
 WasA WATCHUNG SILT LOAM

SCALE: 1" = 50'

625 WEST RIDGE PIKE, SUITE E-100
 CONSHOHOCKEN, PA 19428
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KEVIN MCKEON, P.E.
 NEW JERSEY
 PROFESSIONAL ENGINEER NO GE32586

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TRANSCONTINENTAL GAS PIPE LINE COMPANY, LLC.
 POST CONSTRUCTION STORMWATER MANAGEMENT PLAN
 NORTHEAST SUPPLY ENHANCEMENT PROJECT
 COMPRESSOR STATION NO. 206 - TRAP ROCK ACCESS ROAD
 EXISTING CONDITIONS AND SOILS MAP (SHEET 1 OF 3)
 FRANKLIN TOWNSHIP, SOMERSET COUNTY, NJ

DRAWN BY: GMS DATE: 06/15/17 ISSUED FOR BID: TBD SCALE: 1"=50'

CHECKED BY: PPH DATE: 06/15/17 ISSUED FOR CONSTRUCTION: TBD REVISION: 11

APPROVED BY: KDM DATE: 06/15/17 DRAWING NUMBER: SHEET 2 OF 13

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LEGEND


- EXISTING FEATURES**
- 265 EXISTING MAJOR CONTOUR
 - EXISTING MINOR CONTOUR
 - STREAM CENTERLINE
 - WETLAND
 - PARCEL LINE
 - EXISTING ACCESS ROADS
 - X EXISTING FENCE
 - OHE EXISTING OVERHEAD POWER LINE
 - EXISTING PIPELINE
 - EXISTING RIGHT OF WAY
 - SOIL TYPE BOUNDARY
 - WasA SOIL TYPE

- PROPOSED FEATURES**
- LOD LIMIT OF DISTURBANCE



- NOTES:**
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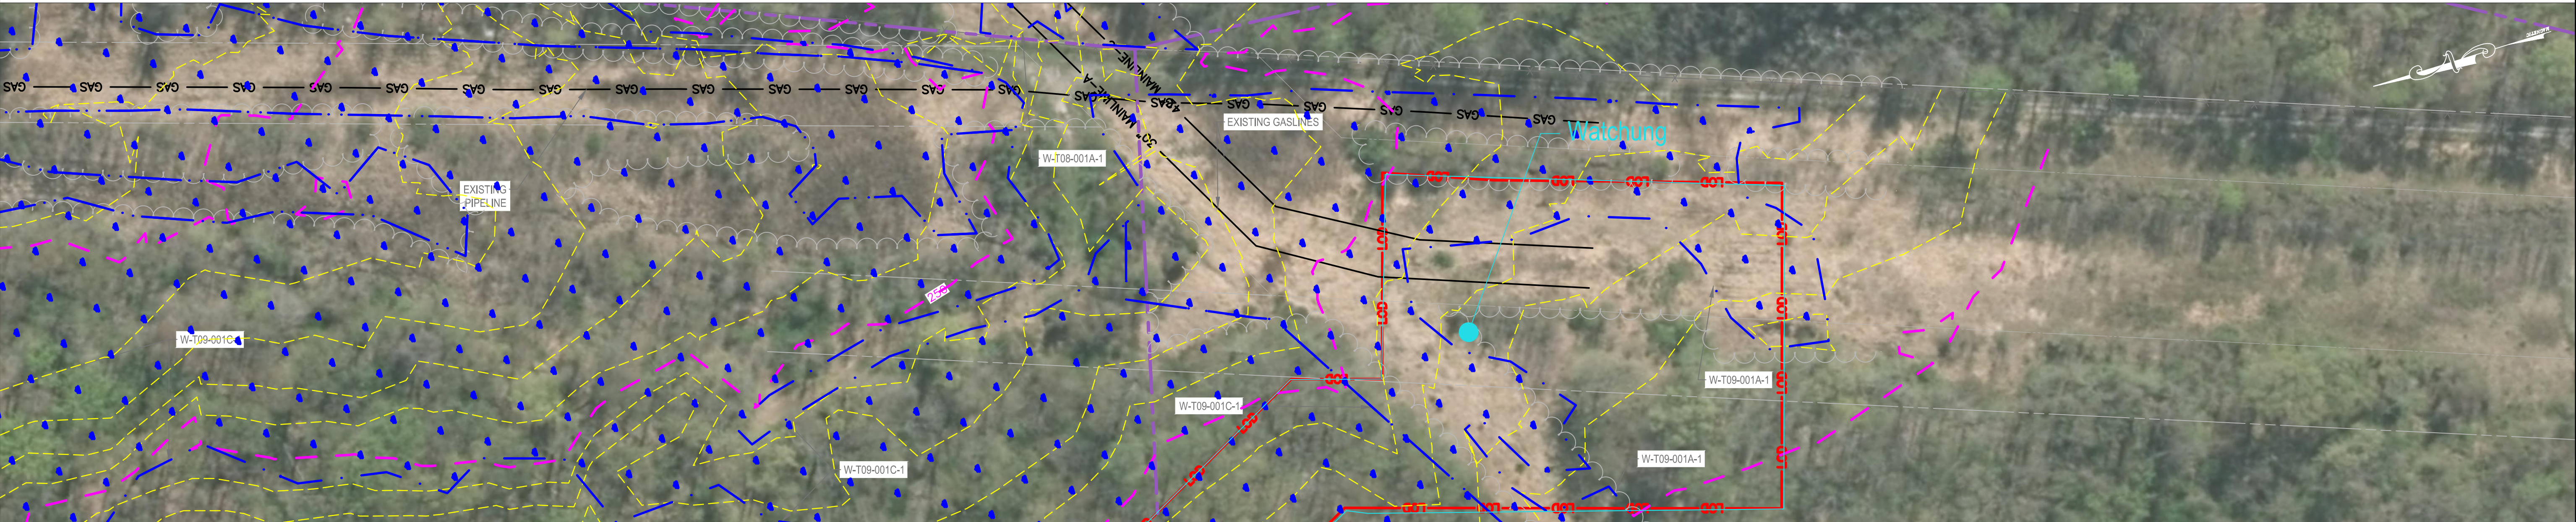
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 COMPRESSOR STATION NO. 206 - TRAP ROCK ACCESS ROAD
 EXISTING CONDITIONS AND SOILS MAP (SHEET 2 OF 3)
 FRANKLIN TOWNSHIP, SOMERSET COUNTY, NJ

Williams
 GAS PIPELINE

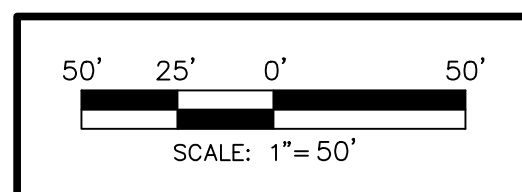DRAWN BY: GMS	DATE: 06/15/17	ISSUED FOR BID: TBD	SCALE: 1"=50'
CHECKED BY: PPH	DATE: 06/15/17	ISSUED FOR CONSTRUCTION: TBD	REVISION: 11
APPROVED BY: KDM	DATE: 06/15/17	DRAWING NUMBER:	SHEET 3 OF 13
WO: 1185732			

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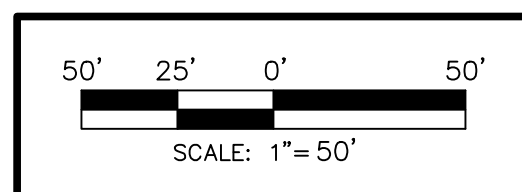
LEGEND

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	WETLAND		
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 - PROPOSED COMPRESSOR STATION SITE WILL BE STABILIZED WITH CLEAN CRUSHED ROCK (GRAVEL).

SOIL LEGEND:

MJA	MOUNT LUCAS SILT LOAMS
NehB	NESHAMINY SILT LOAMS
WasA	WATCHUNG SILT LOAM





KEVIN MCKEON, P.E.
 NEW JERSEY
 PROFESSIONAL ENGINEER NO GE32586

REVISIONS						
NO.	DATE	BY	DESCRIPTION	W.O. NO.	CHK	APP.
0	06/15/17	GMS	SUBMITTED TO SOMERSET-UNION SCD	1185732	PPH	KDM
1	08/11/17	GMS	REVISED NIDEP AND SCD SUBMISSION	1185732	PPH	KDM
2	01/05/18	GMS	REVISED WORKSPACE	1185732	PPH	KDM
3	02/09/18	GMS	REVISED SUBMISSION TO SOMERSET-UNION SCD	1185732	PPH	KDM
4	06/05/18	PPH	SUBMITTED TO NJDEP	1185732	TFP	KDM
5	08/24/18	GMS	SUBMITTED TO NJDEP	1185732	PPH	KDM
6	02/01/19	PPH	SUBMITTED TO NJDEP	1185732	TFP	KDM
7	04/22/19	PPH	SUPPLEMENTAL INFORMATION	1185732	PPH	KDM
8	05/03/19	PPH	REVISED BASIN GRADING	1185732	PPH	KDM
9	06/07/19	PPH	REVISED BASIN GRADING	1185732	GMS	KDM
10	06/24/19	PPH	LOD REDUCTION IN WETLAND TRANSITION	1185732	GMS	KDM
11	01/15/20	PPH	NJDEP SUBMISSION	1185732	TFP	KDM

TRANSCONTINENTAL GAS PIPE LINE COMPANY, LLC.
 POST CONSTRUCTION STORMWATER MANAGEMENT PLAN
 NORTHEAST SUPPLY ENHANCEMENT PROJECT
 COMPRESSOR STATION NO. 206 - TRAP ROCK ACCESS ROAD
 EXISTING CONDITIONS AND SOILS MAP (SHEET 3 OF 3)
 FRANKLIN TOWNSHIP, SOMERSET COUNTY, NJ

DRAWN BY: GMS	DATE: 06/15/17	ISSUED FOR BID: TBD	SCALE: 1"=50'
CHECKED BY: PPH	DATE: 06/15/17	ISSUED FOR CONSTRUCTION: TBD	REVISION: 11
APPROVED BY: KDM	DATE: 06/15/17	DRAWING NUMBER:	SHEET 4 OF 13
WO: 1185732			

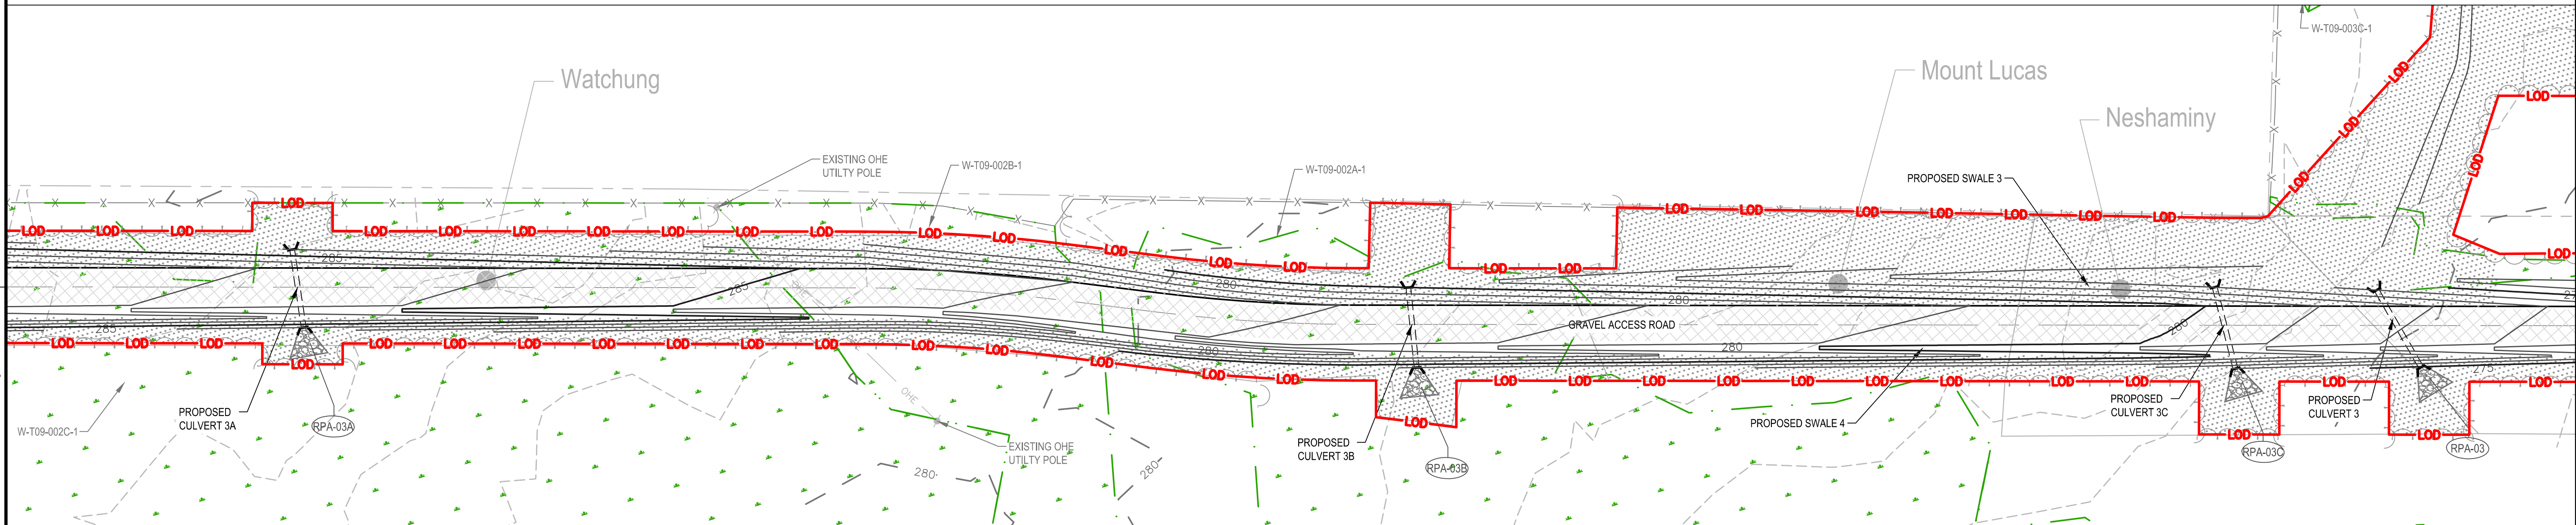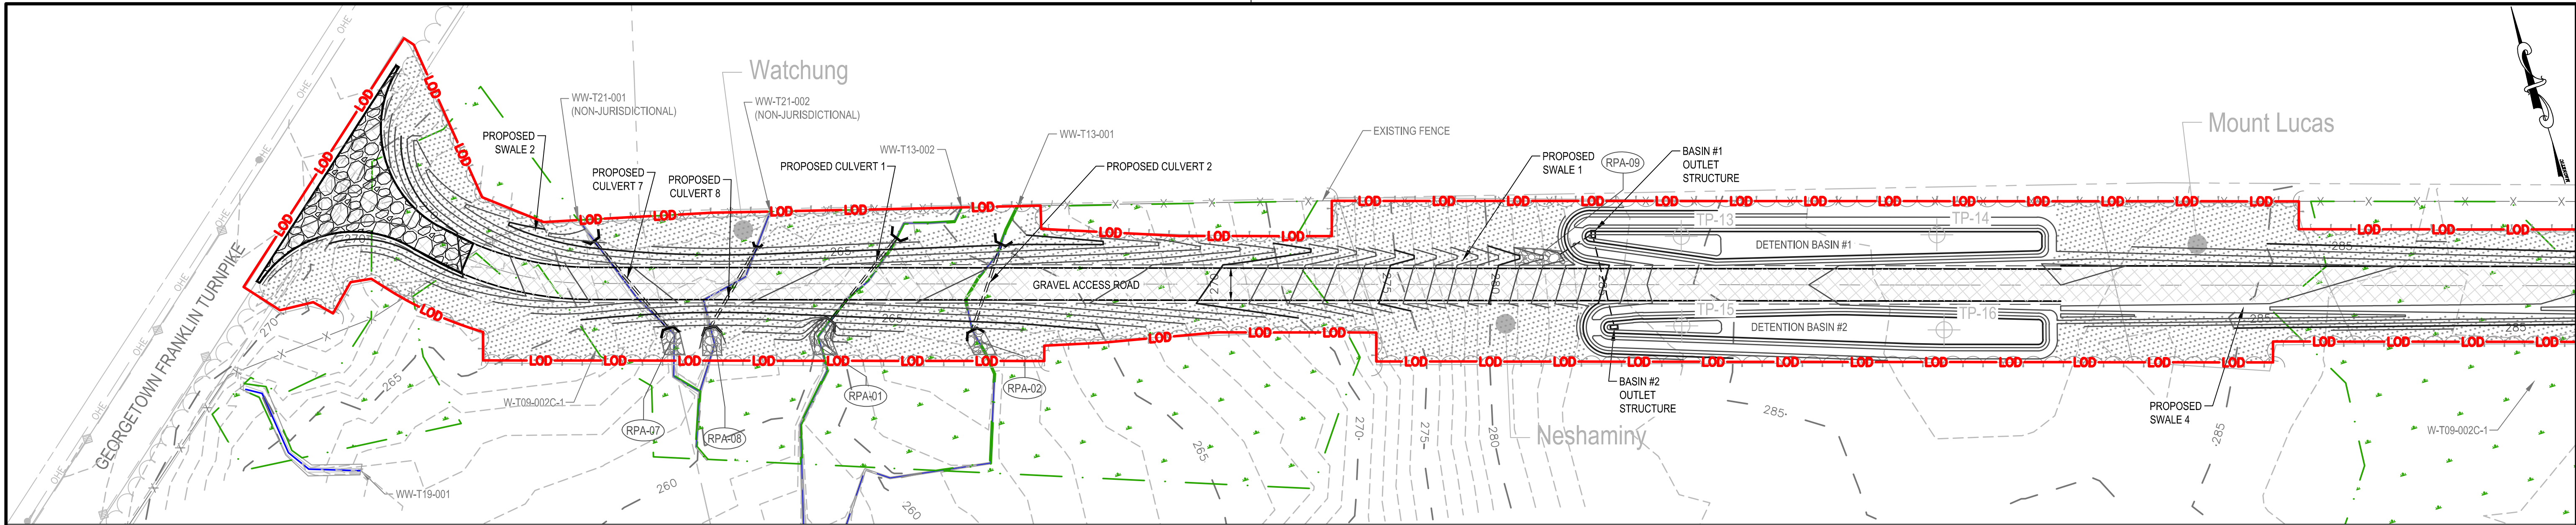

LEGEND

EXISTING FEATURES		PROPOSED FEATURES	
	EXISTING MAJOR CONTOUR		LIMIT OF DISTURBANCE
	EXISTING MINOR CONTOUR		PROPOSED CONTOUR MAJOR
	STREAM CENTERLINE		PROPOSED CONTOUR MINOR
	WETLAND		PROPOSED PIPELINE
	EXISTING TREE LINE		CULVERT
	PARCEL LINE		RIP RAP APRON
	EXISTING ACCESS ROADS		PROPOSED FENCE
	EXISTING FENCE		PROPOSED TREE LINE
	EXISTING OVERHEAD POWER LINE		PROPOSED GRAVEL
	EXISTING PIPELINE		PROPOSED CONCRETE
	EXISTING RIGHT OF WAY		RIPRAP SLOPE PROTECTION
	SOIL TYPE BOUNDARY		PROPOSED BRUSH SEED MIX
	SOIL TYPE		SOIL TEST LOCATION

NOTES

- THIS BASE MAP WAS PREPARED ON AERIAL TOPOGRAPHY AND ACTUAL FIELD SURVEY PROVIDED BY WILLIAMS AND ARE REFERENCED TO THE NEW JERSEY STATE PLANE DATUM.
- PROPERTY LINE INFORMATION PROVIDED BY WILLIAMS.
- PROPOSED COMPRESSOR STATION SITE WILL BE STABILIZED WITH CLEAN CRUSHED ROCK (GRAVEL).

SOIL LEGEND:

MuA MOUNT LUCAS SILT LOAMS
 NehB NESHAMINY SILT LOAMS
 WasA WATCHUNG SILT LOAM

SCALE: 1" = 50'

KEVIN MCKEON, P.E.

NEW JERSEY
PROFESSIONAL ENGINEER NO GE32586

REVISIONS					
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TRANSCONTINENTAL GAS PIPE LINE COMPANY, LLC.
 POST CONSTRUCTION STORMWATER MANAGEMENT PLAN
 NORTHEAST SUPPLY ENHANCEMENT PROJECT
 COMPRESSOR STATION NO. 206 - TRAP ROCK ACCESS ROAD
 POST CONSTRUCTION STORMWATER MANAGEMENT PLAN (SHEET 1 OF 3)
 FRANKLIN TOWNSHIP, SOMERSET COUNTY, NJ

Drawn By: & Date/Time: harsse Jan 10, 2020 - 12:40pm
 Drawing Location & Name: S:\Projects\ENV\60537393_NESE_CS206\900-CAD-GIS\910-CAD\20-PCSM SHEETS\05-07 - PCSM Plan CS 206.dwg


WasA

SHEET 5
OF 13

LEGEND


- EXISTING FEATURES**
- 265 — EXISTING MAJOR CONTOUR
 - EXISTING MINOR CONTOUR
 - STREAM CENTERLINE
 - WETLAND
 - EXISTING TREE LINE
 - PARCEL LINE
 - EXISTING ACCESS ROADS
 - EXISTING FENCE
 - OHE — EXISTING OVERHEAD POWER LINE
 - EXISTING PIPELINE
 - EXISTING RIGHT OF WAY
 - SOIL TYPE BOUNDARY
 - SOIL TYPE

- PROPOSED FEATURES**
- LOD — LIMIT OF DISTURBANCE
 - PROPOSED CONTOUR MAJOR
 - PROPOSED CONTOUR MINOR
 - GAS — PROPOSED PIPELINE
 - CULVERT
 - RIP RAP APRON
 - PROPOSED FENCE
 - PROPOSED TREE LINE
 - PROPOSED GRAVEL
 - PROPOSED CONCRETE
 - RIPRAP SLOPE PROTECTION
 - PROPOSED BRUSH SEED MIX
 - TP-8 — SOIL TEST LOCATION

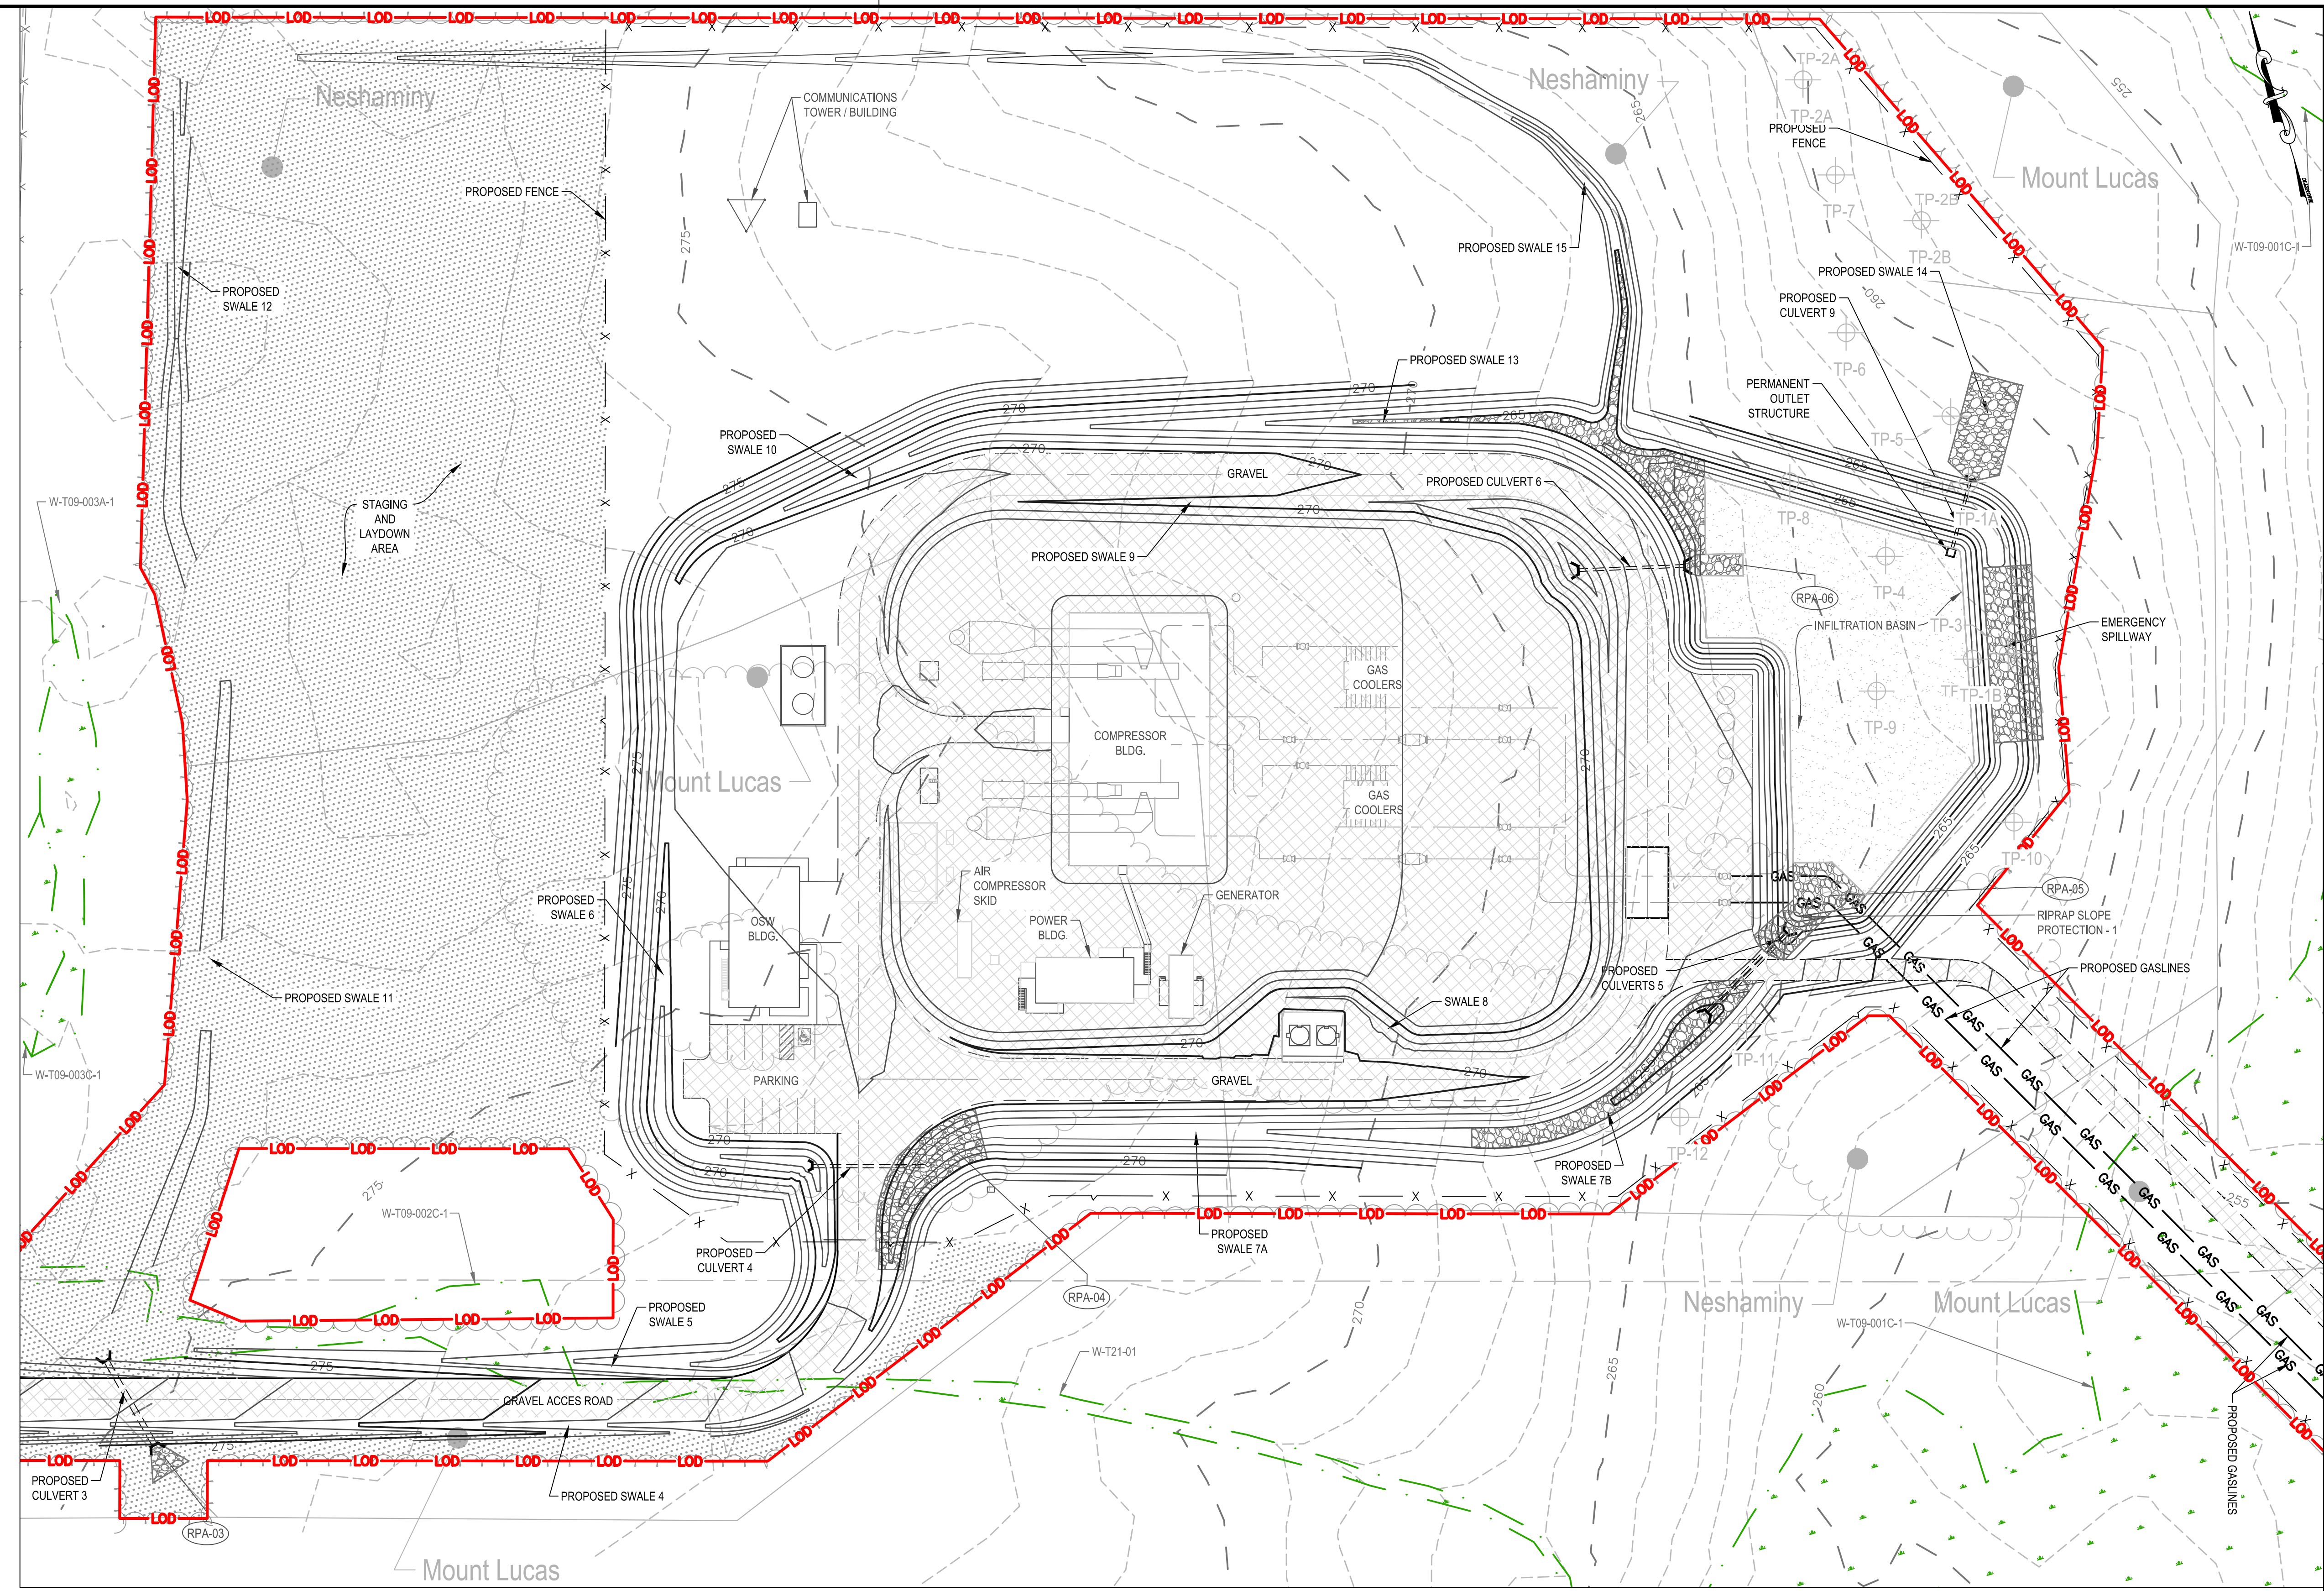

- NOTES**
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 2. PROPERTY LINE INFORMATION PROVIDED BY WILLIAMS.
 3. PROPOSED COMPRESSOR STATION SITE WILL BE STABILIZED WITH CLEAN CRUSHED ROCK (GRAVEL).

- SOIL LEGEND**
- M/A MOUNT LUCAS SILT LOAMS
 - NshB NESHAMINY SILT LOAMS
 - WasA WATCHUNG SILT LOAM

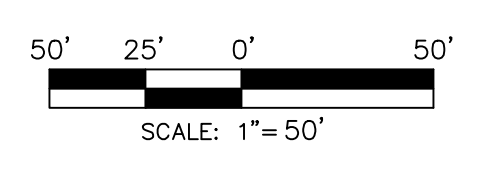

AECOM
 625 WEST RIDGE PIKE, SUITE E-100
 CONSHOHOCKEN, PA 19428
 (610) 832-3500

KEVIN MCKEON, P.E.
 NEW JERSEY
 PROFESSIONAL ENGINEER NO. GE32586

REVISIONS						
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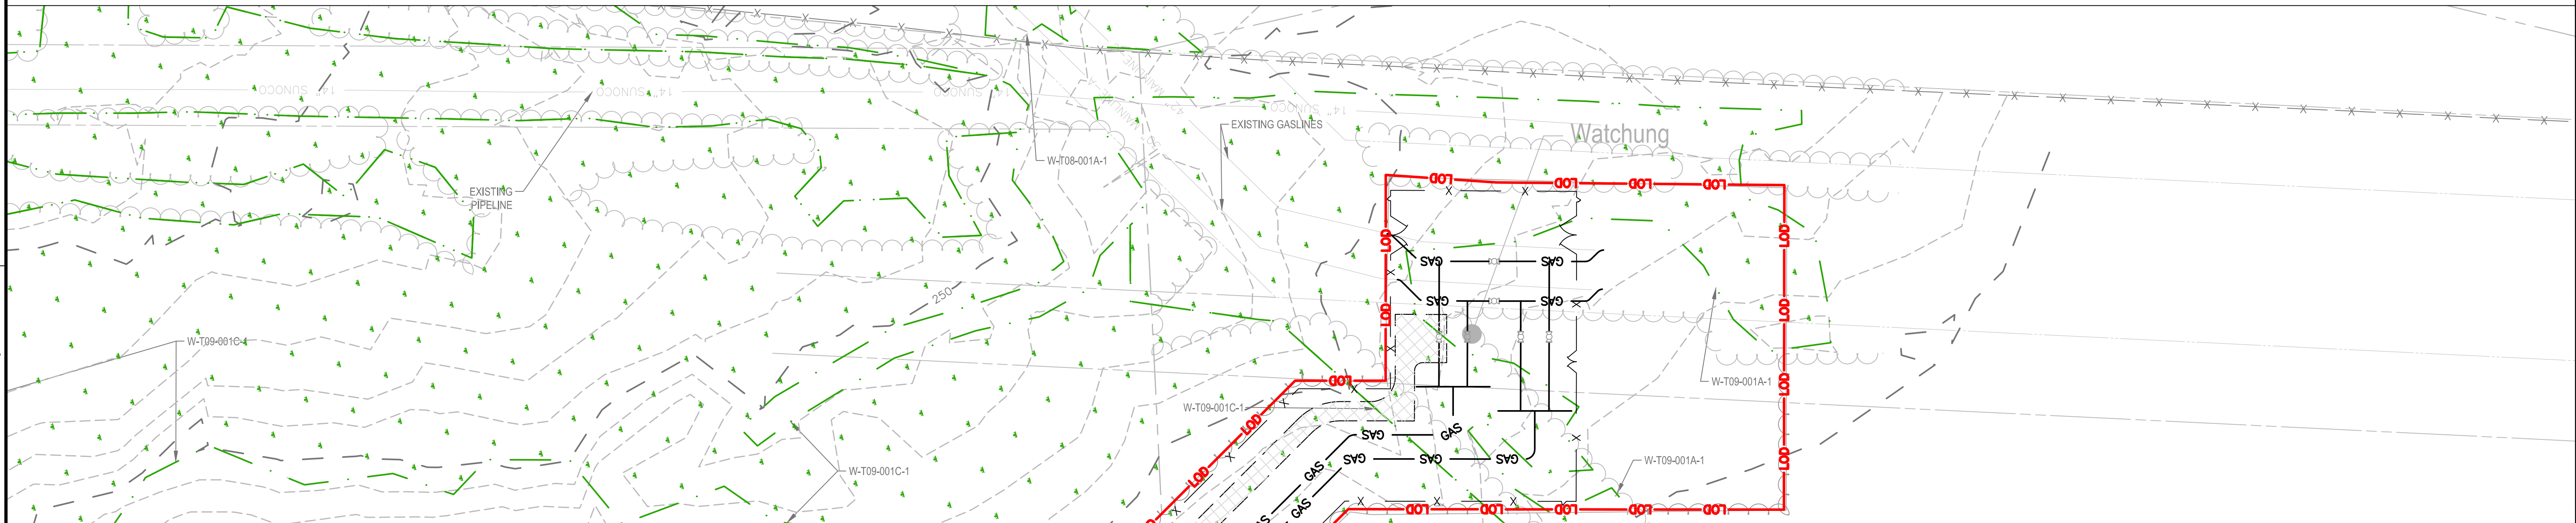
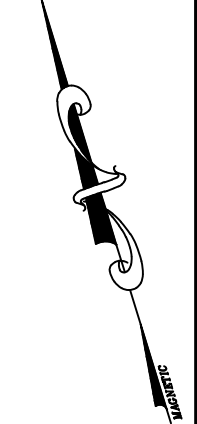
TRANSCONTINENTAL GAS PIPE LINE COMPANY, LLC.
 POST CONSTRUCTION STORMWATER MANAGEMENT PLAN
 NORTHEAST SUPPLY ENHANCEMENT PROJECT
 COMPRESSOR STATION NO. 206 - TRAP ROCK ACCESS ROAD
 POST CONSTRUCTION STORMWATER MANAGEMENT PLAN (SHEET 2 OF 3)
 FRANKLIN TOWNSHIP, SOMERSET COUNTY, NJ

Williams
 GAS PIPELINE

DRAWN BY: GMS	DATE: 06/15/17	ISSUED FOR BID: TBD	SCALE: 1"=50'
CHECKED BY: PPH	DATE: 06/15/17	ISSUED FOR CONSTRUCTION: TBD	REVISION: 11
APPROVED BY: KDM	DATE: 06/15/17	DRAWING NUMBER:	
WO: 1185732			

SHEET 6
OF 13

Drawn By & Date/Time: hoesse Jan 10, 2020 - 12:40pm
 Drawing Location & Name: S:\Projects\ENV\60537393_NESE_CS206\900-CAD-GIS\910-CAD\20-PCSM SHEETS\05-07 - PCSM Plan CS 206.dwg



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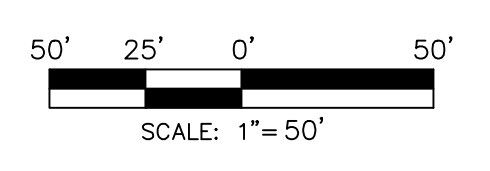
LEGEND

EXISTING FEATURES		PROPOSED FEATURES	
265	EXISTING MAJOR CONTOUR	LOD	LIMIT OF DISTURBANCE
- - -	EXISTING MINOR CONTOUR	- - -	PROPOSED CONTOUR MAJOR
---	STREAM CENTERLINE	- - -	PROPOSED CONTOUR MINOR
WETLAND	WETLAND	GAS	PROPOSED PIPELINE
---	EXISTING TREE LINE	- - -	CULVERT
---	PARCEL LINE	X	RIP RAP APRON
---	EXISTING ACCESS ROADS	X	PROPOSED FENCE
---	EXISTING FENCE	---	PROPOSED TREE LINE
OHE	EXISTING OVERHEAD POWER LINE	---	PROPOSED GRAVEL
---	EXISTING PIPELINE	---	PROPOSED CONCRETE
---	EXISTING RIGHT OF WAY	---	RIPRAP SLOPE PROTECTION
---	SOIL TYPE BOUNDARY	---	PROPOSED BRUSH SEED MIX
---	SOIL TYPE	TP-8	SOIL TEST LOCATION

- NOTES:**
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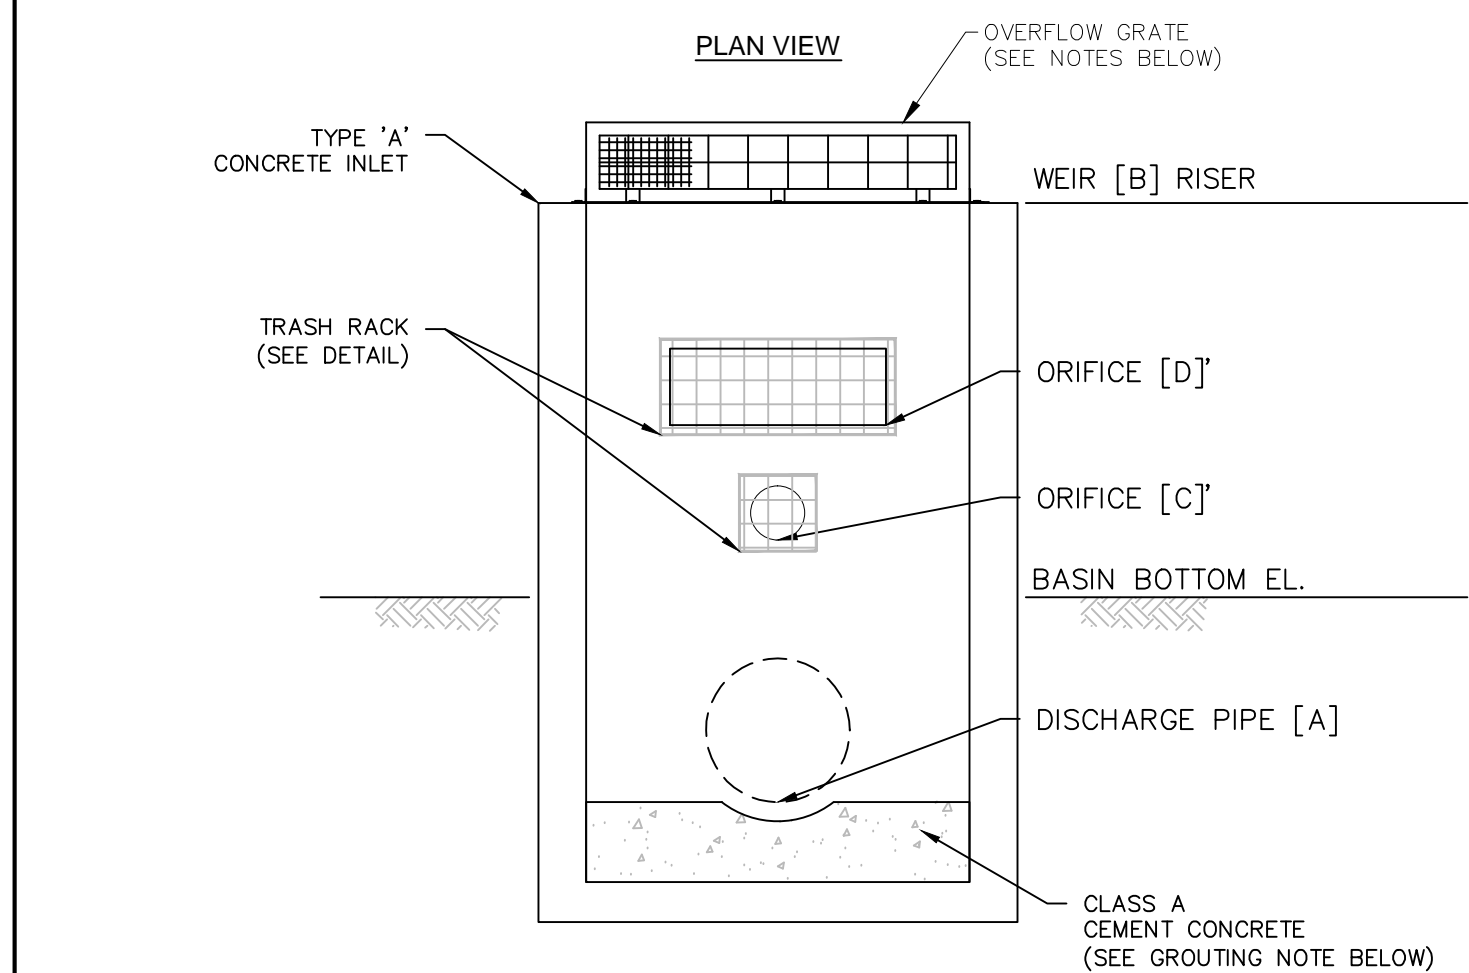
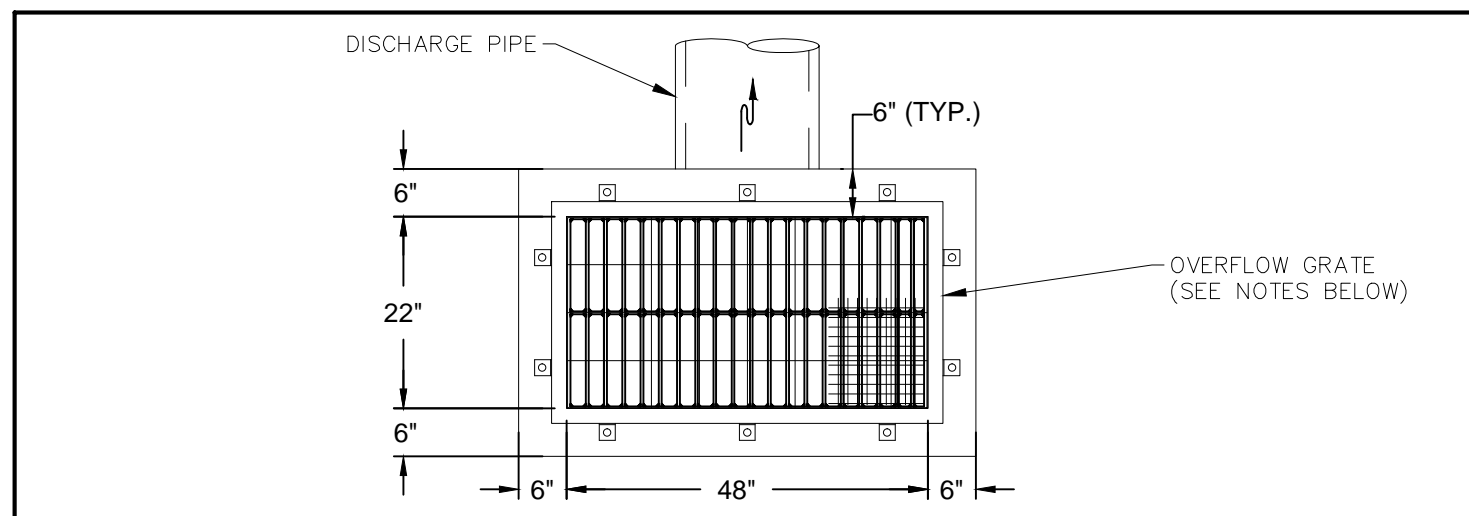
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TRANSCONTINENTAL GAS PIPE LINE COMPANY, LLC.
 POST CONSTRUCTION STORMWATER MANAGEMENT PLAN
 NORTHEAST SUPPLY ENHANCEMENT PROJECT
 COMPRESSOR STATION NO. 206 - TRAP ROCK ACCESS ROAD
 POST CONSTRUCTION STORMWATER MANAGEMENT PLAN (SHEET 3 OF 3)
 FRANKLIN TOWNSHIP, SOMERSET COUNTY, NJ

Williams
 GAS PIPELINE

DRAWN BY: GMS	DATE: 06/15/17	ISSUED FOR BID: TBD	SCALE: 1"=50'
CHECKED BY: PPH	DATE: 06/15/17	ISSUED FOR CONSTRUCTION: TBD	REVISION: 11
APPROVED BY: KDM	DATE: 06/15/17	DRAWING NUMBER:	SHEET 7 OF 13
WO: 1185732			

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OVERFLOW GRATE NOTES:
 AN OVERFLOW GRATE IS DESIGNED TO PREVENT OBSTRUCTION OF THE STRUCTURE. THE GRATE MUST COMPLY WITH THE FOLLOWING REQUIREMENTS:

1. THE OVERFLOW GRATE MUST BE SECURED TO THE OUTLET STRUCTURE BUT REMOVABLE FOR EMERGENCIES AND MAINTENANCE.
2. THE OVERFLOW GRATE SPACING MUST BE NO GREATER THAN 2 INCHES ACROSS THE SMALLEST DIMENSION; AND
3. THE OVERFLOW GRATE MUST BE CONSTRUCTED OF RIGID, DURABLE, AND CORROSION RESISTANT MATERIAL AND DESIGNED TO WITHSTAND A PERPENDICULAR LIVE LOADING OF 300 LBS/SF.


GROUTING NOTE:
 THE SPACE BELOW THE INVERT OF THE DISCHARGE PIPE MUST BE FILLED WITH MATERIAL, SUCH AS CONCRETE, A MIXTURE OF SAND AND CEMENT, OR SIMILAR GROUTING MATERIAL, SUCH THAT WATER WILL NOT POND IN THE OUTLET STRUCTURE. THIS MATERIAL MUST BE SLOPED TOWARDS THE DISCHARGE PIPE TO FACILITATE DRAINAGE.

BASIN NO.	BASIN BOTTOM		CULVERT [A] OUTFALL		WEIR [B] RISER		ORIFICE [C]		ORIFICE [D]	
	ELEV.	SIZE/MATERIAL	INV. ELEV.	ELEV.	SIZE	INV. ELEV.	SIZE	INV. ELEV.	SIZE	INV. ELEV.
INFILTRATION BASIN	262.00	18" RCP	261.75	265.50	4"	262.15	0.5' H 0.8' W	263.25		

NEW JERSEY
 TRANSCONTINENTAL GAS PIPE LINE CORPORATION
 PROJECT SPECIFIC DETAIL
 COS CONCRETE OUTLET STRUCTURE
 Williams GAS PIPELINE

NOTES:

1. THE SAND MUST MEET ALL THE SPECIFICATIONS FOR CLEAN, MEDIUM-AGGREGATE CONCRETE SAND IN ACCORDANCE WITH AASHTO M-6 OR ASTM C-33, AS CERTIFIED BY A PROFESSIONAL ENGINEER LICENSED IN THE STATE OF NEW JERSEY
2. THE MAXIMUM PERCENTAGE OF FILES IN 15%
3. THE MINIMUM TESTED INFILTRATION RATE IS 20 INCHES/HOUR
4. THE USE OF TOPSOIL AND VEGETATION IS PROHIBITED
5. FILTER FABRIC (NON-WOVEN, 8 OZ/SY) IS REQUIRED ALONG THE SIDES OF THE INFILTRATION BASIN TO PREVENT THE MIGRATION OF FINE PARTICLES FROM THE SURROUNDING SOIL; FILTER FABRIC MAY NOT BE USED ALONG THE BOTTOM OF THE BASIN BECAUSE IT MAY RESULT IN A LOSS OF PERMEABILITY
6. SAND MEDIA MUST BE PLACED IN LIFTS NOT TO EXCEED 6 INCHES
7. PROCEDURE:
 - 7.1. EXCAVATE TO REQUIRED MINIMUM THICKNESS OF SAND MEDIA. SCARIFY AND DE-COMPACT THE EXPOSED SUBGRADE IN ACCORDANCE WITH THE 'BASIN COMPACTION NOTES', TO A DEPTH OF 6" - 12"
 - 7.2. REMOVE ROCKS LARGER THAN 3 INCHES
 - 7.3. PREPARE AND PLACE THE SAND MEDIA PER NOTES 1-6 ABOVE.

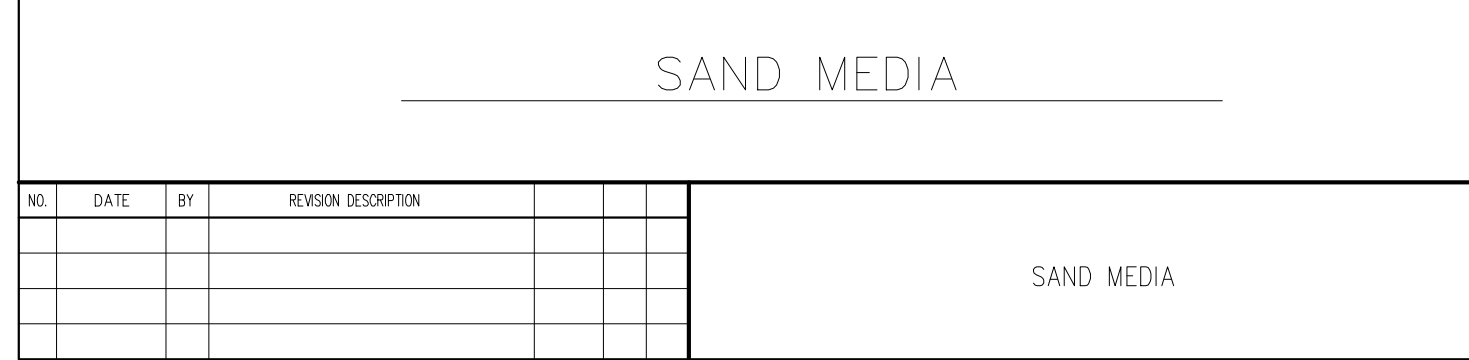

SAND MEDIA

NO.	DATE	BY	REVISION DESCRIPTION	NO.	CHK.	APP.

NOTES:
 1. CONTRACTOR SHALL EXCAVATE THE BASIN FROM OUTSIDE THE LIMITS OF THE BASIN. IF CONTRACTOR NEEDS TO ENTER THE BASIN FOOTPRINT, CONTRACTOR SHALL ONLY USE LOW CONTACT PRESSURE EQUIPMENT TO GRADE THE BASIN TO MINIMIZE COMPACTING THE SOILS.

EMBANKMENT			BARREL				
Z1	Z2	TOP ELEV. (FEET)	TOP WIDTH (FEET)	INVERT ELEV. (FEET)	OUTLET ELEV. (FEET)	DIA (INCH)	MATERIAL
3	3	267.00	10	261.75	261.20	18	RCP

BASIN NO.	WEIR		LINING		CHANNEL		DISSIPATER						
	Z3 (FT)	Z4 (FT)	TOP ELEV WTE (FT)	CREST ELEV WCE (FT)	WIDTH Ww (FT)	RIPRAP SIZE (R-...)	RIPRAP THICK. Lrt (IN)	Z5 (FT)	DEPTH Cd (FT)	LENGTH DI (FT)	WIDTH Dw (FT)	RIPRAP SIZE (R-...)	RIPRAP THICK. Drt (IN)
1	3	3	267.00	266.00	100	4	18	3	1	5	100	4	18

NEW JERSEY
 TRANSCONTINENTAL GAS PIPE LINE CORPORATION
 STANDARD ENVIRONMENTAL DETAIL
 Williams GAS PIPELINE

BRUSH SEEDING MIX FOR WETLAND AREAS (ERNSET SEED FACW MEADOW MIX)

COMMON NAME	SCIENTIFIC NAME
FOX SEDGE	CAREX VULPINODEA
HOP SEDGE	CAREX LUPULINA
BLUNT BROOM SEDGE	CAREX SCOPARIA
BLADDER (STAR) SEDGE	CAREX INTUMESCENS
VIRGINIA WILDRIE	ELYMUS VIRGINICUS
OXEYE SUNFLOWER	HELIOPSIS HELIANTHOIDES
NARROWLEAF BLUE EYED GRASS	SISYRINCHIUM ANGUSTIFOLIA
SEEDBOX	LUDWIGIA ALTERNIFOLIA
RATTLESNAKE GRASS	GLYCERIA CANADENSIS
GREAT BLUE LOBELIA	LOBELIA SIPHILITICA
WATER PLANTAIN	ALISMA SUBCORDATUM
SWAMP MILKWEED	ASCLEPIAS INCARNATA
BONESET	EUPATORIUM PERFORLIATUM
LURID SEDGE	CAREX LURIDA
SOFT RUSH	JUNCUS EFFUSUS
SENSITIVE FERN	DNDOLEA SENSIBILIS
GREEN BULRUSH	SCIRPUS ATROVIRENS
WOOLGRASS	SCIRPUS CYPERINUS
SPOTTED JOE-PYE WEED	EUPATORIUM MACULATUM
BLUE VERVAIN	VERBANA HASTATA
DITCH STONECROP	PENTHORUM SEDOIDES
MONKEY FLOWER	MIMULUS RINGENS
NEW ENGLAND ASTER	ASTER NOVVAE-ANGLIAE
FLAT-TOP WHITE ASTER	ASTER UMBELLATUS
SLENDER MOUNTAINMINT	PHYCANTHEMUM TENUIFOLIUM

* SEED APPLICATION RATES SHOULD FOLLOW THE MANUFACTURER'S RECOMMENDATION FOR THE INDIVIDUAL SEED MIX.

BRUSH SEEDING MIX FOR TRANSITION AND UPLAND AREAS (ERNSET SEED CUSTOM NATIVE UPLAND WILDLIFE FORAGE AND COVER MIX)

COMMON NAME	SCIENTIFIC NAME
VIRGINIA WILD RYE	ELYMUS VIRGINICUS
LITTLE BLUESTEM	SCHIZACHYRIUM SCOPARIUM
SWITCHGRASS	PANICUM VIRGATUM
INDIANGRASS	SORGHASTRUM NUTANS
EASTERN GAMMA GRASS	TRIPSACUM DACTYLOIDES
FDWL BLUEGRASS	PDA PALUSTRIS
BIG BLUESTEM	ANDROPPOGON GERARDII
BLACK EYED SUSAN	RUBRICKIA HIRTA
SHOWY TICK-TREFOIL	DESMODIUM CANADENSE
OX EYE SUNFLOWER	HELIOPSIS HELIANTHOIDES

* SEED APPLICATION RATES SHOULD FOLLOW THE MANUFACTURER'S RECOMMENDATION FOR THE INDIVIDUAL SEED MIX.

NOTES:
 FOR SYSTEMS DESIGNED WITH AN OUTLET STRUCTURE, TRASH RACKS MUST BE INSTALLED AT THE INTAKE TO THE OUTLET STRUCTURE. THEY MUST MEET THE FOLLOWING CRITERIA:

1. PARALLEL BARS WITH 1-INCH SPACING BETWEEN THE BARS UP TO THE ELEVATION OF THE WATER QUALITY DESIGN STORM;
2. PARALLEL BARS HIGHER THAN THE ELEVATION OF THE WATER QUALITY DESIGN STORM MUST BE SPACED NO GREATER THAN ONE-THIRD THE WIDTH OF THE DIAMETER OF THE ORIFICE, WITH MINIMUM SPACING BETWEEN BARS OF 1-INCH AND A MAXIMUM SPACING BETWEEN BARS OF SIX INCHES;
3. THE TRASH RACK MUST BE DESIGNED SO AS NOT TO ADVERSELY AFFECT THE HYDRAULIC PERFORMANCE OF THE OUTLET PIPE OR STRUCTURE;
4. CONSTRUCTED OF RIGID, DURABLE AND CORROSION-RESISTANT MATERIAL; AND
5. DESIGNED TO WITHSTAND PERPENDICULAR LIVE LOADING OF 300 LBS/SF.

NEW JERSEY
 TRANSCONTINENTAL GAS PIPE LINE CORPORATION
 STANDARD ENVIRONMENTAL DETAIL
 Williams GAS PIPELINE

SOMERSET-UNION SOIL CONSERVATION DISTRICT BASIN COMPACTION NOTES:

1. INSPECT SITE. IF TRAFFIC HAS LEFT THE SOIL COMPACTED, THE AREA MUST BE RE-TILLED AND FIRMED IN ACCORDANCE WITH ABOVE.
2. THE SURFACE SHOULD BE SCARIFIED 6" TO 12" WHERE THERE HAS BEEN SOIL COMPACTED. THIS WILL HELP INSURE A GOOD BOND BETWEEN THE TOPSOIL AND SUBSOIL. THIS PRACTICE IS PERMISSIBLE ONLY WHERE THERE IS NO DANGER TO UNDERGROUND UTILITIES (CABLES, IRRIGATION SYSTEMS, ETC.).
3. SOIL COMPACTION RESULTING FROM LAND GRADING ACTIVITIES CAN IMPACT THE INFILTRATION RATE OF THE SOIL. RESTORATION OF COMPACTED SOILS THROUGH DEEP TILLAGE (6" TO 12") MAY BE REQUIRED IN PLANNED PERVIOUS AREAS TO ENHANCE THE INFILTRATION RATE OF THE DISTURBED SOIL. THIS PRACTICE IS PERMISSIBLE ONLY WHERE THERE IS NO DANGER TO UNDERGROUND UTILITIES (CABLES, IRRIGATION SYSTEMS, ETC.).
4. TO PREVENT COMPACTION OF THE SUBSOIL WHICH WILL REDUCE ITS INFILTRATION CAPACITY, BASINS SHOULD BE EXCAVATED WITH LIGHT EARTH MOVING EQUIPMENT (LOW GROUND PRESSURE), PREFERABLY WITH TRACKS OR OVER-SIZED TIRES RATHER THAN THE NORMAL RUBBER TIRES. ONCE THE FINAL CONSTRUCTION PHASE IS REACHED, THE FLOOR OF THE BASIN SHALL BE SCARIFIED AND DE-COMPACTED DEEPLY TILLED WITH A ROTARY TILLER OR DISC HARROW AND SMOOTHED OVER WITH A LEVELING DRAG OR EQUIVALENT GRADING EQUIPMENT
5. FOR BASINS, ANNUAL TILLING OPERATIONS MAINTAIN INFILTRATION CAPACITY. DEEP TILLING CAN BE USED TO BREAKUP CLOGGED SURFACE LAYERS FOLLOWED BY RE-GRADING AND LEVELING. SAND OR ORGANIC MATTER CAN BE TILLED INTO THE BASIN FLOOR TO PROMOTE A RESTORED INFILTRATION CAPACITY. SEDIMENT REMOVAL PROCEDURES SHOULD NOT BE UNDERTAKEN UNTIL THE BASIN IS THOROUGHLY DRY. THE TOP LAYER SHOULD BE REMOVED BY LIGHT EQUIPMENT TO PREVENT COMPACTION. THE REMAINING SOIL CAN BE RE-TILLED.

BASIN COMPACTION NOTES

NEW JERSEY
 TRANSCONTINENTAL GAS PIPE LINE CORPORATION
 STANDARD ENVIRONMENTAL DETAIL
 Williams GAS PIPELINE



KEVIN MCKEON, P.E.
 NEW JERSEY
 PROFESSIONAL ENGINEER NO. GE23288

REVISIONS


NO.	DATE	BY	DESCRIPTION	W.O. NO.	CHK.	APP.
0	06/15/17	GMS	SUBMITTED TO SOMERSET-UNION SCD	1185732	PPH	KDM
1	08/11/17	GMS	REVISED NJDEP AND SCD SUBMISSION	1185732	PPH	KDM
2	01/05/18	GMS	REVISED WORKSPACE	1185732	PPH	KDM
3	02/09/18	GMS	REVISED SUBMISSION TO SOMERSET-UNION SCD	1185732	PPH	KDM
4	06/05/18	PPH	SUBMITTED TO NJDEP	1185732	TPF	KDM
5	08/24/18	GMS	SUBMITTED TO NJDEP	1185732	PPH	KDM
6	02/01/19	PPH	SUBMITTED TO NJDEP	1185732	TPF	KDM
7	04/22/19	PPH	SUPPLEMENTAL INFORMATION	1185732	PPH	KDM
8	05/03/19	PPH	REVISED BASIN GRADING	1185732	PPH	KDM
9	06/07/19	PPH	REVISED BASIN GRADING	1185732	GMS	KDM
10	06/24/19	PPH	LOAD REDUCTION IN WETLAND TRANSITION	1185732	GMS	KDM
11	01/15/20	PPH	NJDEP SUBMISSION	1185732	TPF	KDM

TRANSCONTINENTAL GAS PIPE LINE COMPANY, LLC.
 POST CONSTRUCTION STORMWATER MANAGEMENT PLAN
 NORTHEAST SUPPLY ENHANCEMENT PROJECT
 COMPRESSOR STATION NO. 206 - TRAP ROCK ACCESS ROAD
 DETAILS (SHEET 1 OF 4)
 FRANKLIN TOWNSHIP, SOMERSET COUNTY, NJ


Williams GAS PIPELINE

DRAWN BY: GMS	DATE: 06/15/17	ISSUED FOR BID: TBD	SCALE: N.T.S.
CHECKED BY: PPH	DATE: 06/15/17	ISSUED FOR CONSTRUCTION: TBD	REVISION: 11
APPROVED BY: KDM	DATE: 06/15/17	DRAWING NUMBER:	SHEET 8 OF 13

Drawn By: & Date/Time: hoase, Jan 10, 2020 - 12:40pm
Drawing Location & Name: S:\Projects\ENV\60537393_NESE_CS206\900-CAD-910-CAD\20-PCSM SHEETS\08-11 - PCSM Detail Sheets.dwg

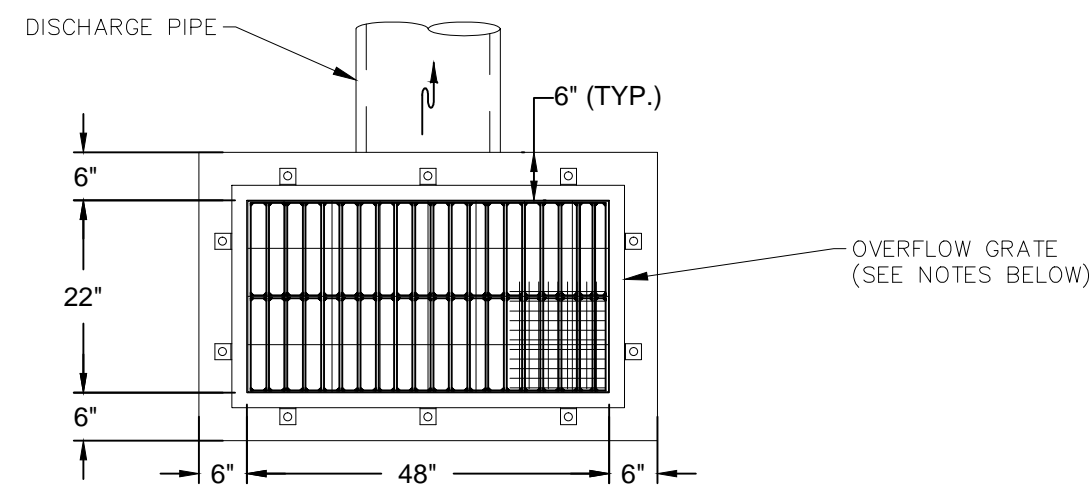

PLAN VIEW

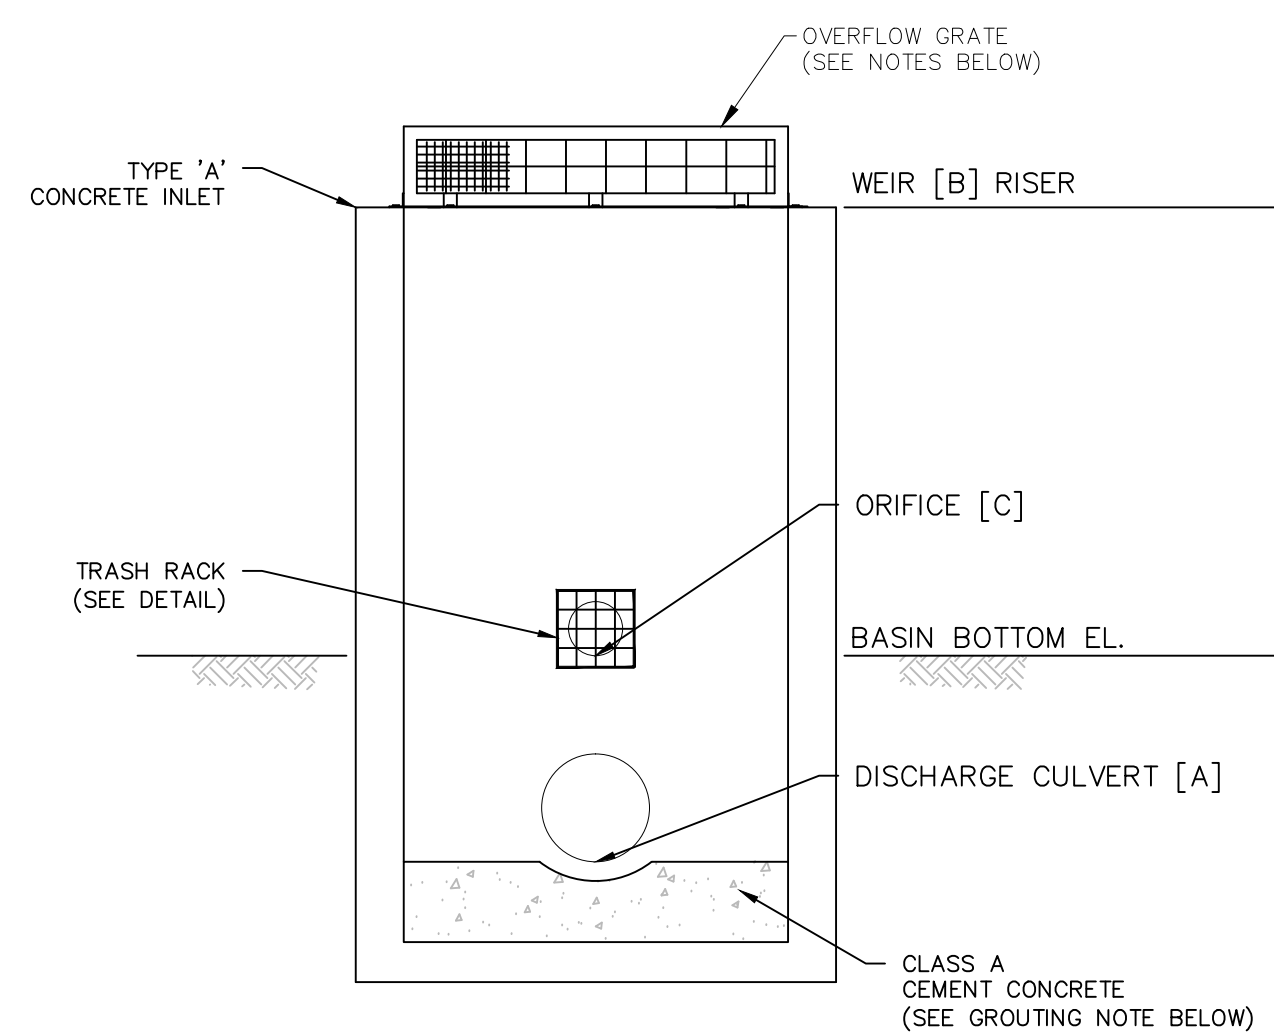

OVERFLOW GRATE NOTES:

AN OVERFLOW GRATE IS DESIGNED TO PREVENT OBSTRUCTION OF THE STRUCTURE. THE GRATE MUST COMPLY WITH THE FOLLOWING REQUIREMENTS:

1. THE OVERFLOW GRATE MUST BE SECURED TO THE OUTLET STRUCTURE BUT REMOVABLE FOR EMERGENCIES AND MAINTENANCE;
2. THE OVERFLOW GRATE SPACING MUST BE NO GREATER THAN 2 INCHES ACROSS THE SMALLEST DIMENSION; AND
3. THE OVERFLOW GRATE MUST BE CONSTRUCTED OF RIGID, DURABLE, AND CORROSION RESISTANT MATERIAL AND DESIGNED TO WITHSTAND A PERPENDICULAR LIVE LOADING OF 300 LBS/SF.


GROUTING NOTE:

THE SPACE BELOW THE INVERT OF THE DISCHARGE PIPE MUST BE FILLED WITH MATERIAL, SUCH AS CONCRETE, A MIXTURE OF SAND AND CEMENT, OR SIMILAR GROUTING MATERIAL, SUCH THAT WATER WILL NOT POND IN THE OUTLET STRUCTURE. THIS MATERIAL MUST BE SLOPED TOWARDS THE DISCHARGE PIPE TO FACILITATE DRAINAGE.

BASIN NO.	BASIN BOTTOM	CULVERT [A] OUTFALL		WEIR [B] RISER	ORIFICE [C]	
	ELEV.	SIZE/MATERIAL	INV. ELEV.	ELEV.	SIZE	INV. ELEV.
1	283.60	6" HDPE	282.00	285.50	2.5"	283.60
2	283.70	6" HDPE	282.55	285.50	2.5"	283.70

NO.	DATE	BY	REVISION DESCRIPTION	NO.	CHK.	APP.

NEW JERSEY
TRANSCONTINENTAL GAS PIPE LINE CORPORATION
PROJECT SPECIFIC DETAIL
COS CONCRETE OUTLET STRUCTURE
Williams GAS PIPELINE

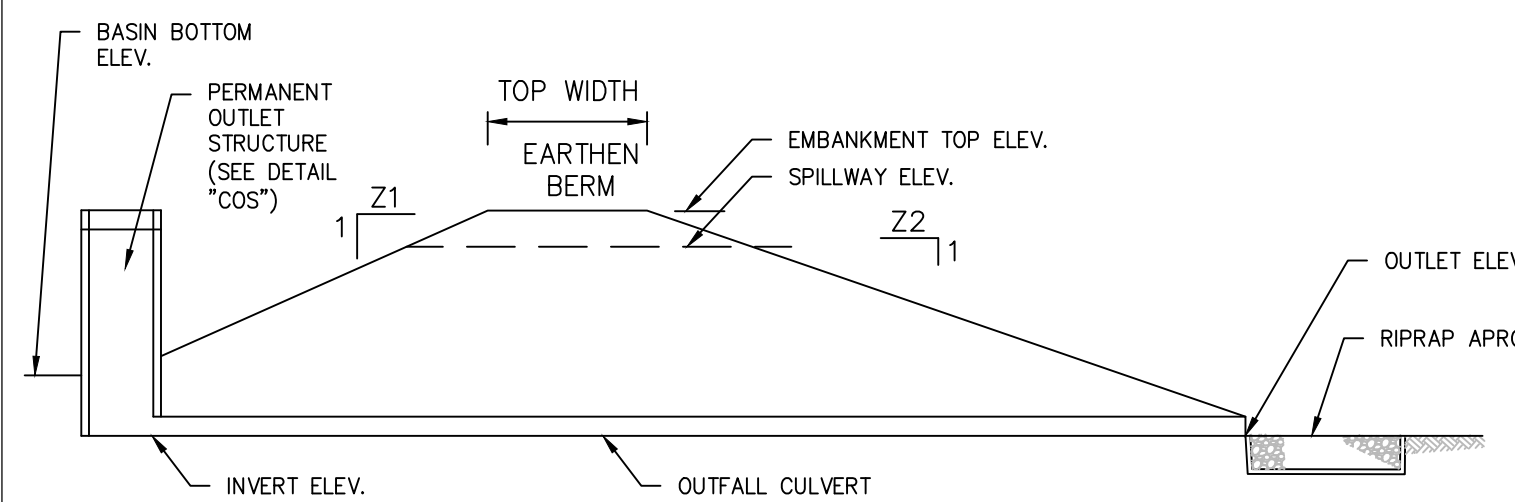


BASIN NO.	EMBANKMENT			SPILLWAY		
	Z1	Z2	ELEV. (FEET)	ELEV. (FEET)	ELEV. (FEET)	WIDTH (FEET)
1	2	2	287.00	5	286.00	10
2	2	2	287.00	5	286.00	10

BASIN NO.	OUTFALL CULVERT					
	INVERT ELEV. (FEET)	OUTLET ELEV. (FEET)	LENGTH (FT)	SLOPE (FT/FT)	DIA (INCH)	MATERIAL
1	282.00	281.75	25	0.01	6	HDPE
2	282.55	282.00	55	0.01	6	HDPE

NO.	DATE	BY	REVISION DESCRIPTION	NO.	CHK.	APP.

NEW JERSEY
TRANSCONTINENTAL GAS PIPE LINE CORPORATION
STANDARD ENVIRONMENTAL DETAIL
DB DETENTION BASIN
Williams GAS PIPELINE

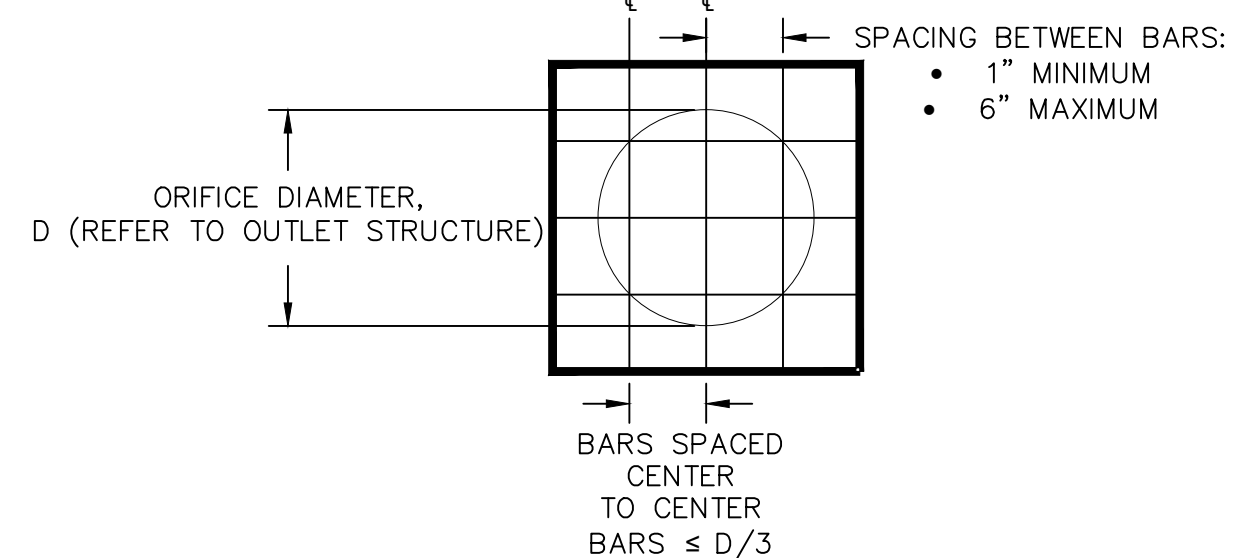


NOTES:

FOR SYSTEMS DESIGNED WITH AN OUTLET STRUCTURE, TRASH RACKS MUST BE INSTALLED AT THE INTAKE TO THE OUTLET STRUCTURE. THEY MUST MEET THE FOLLOWING CRITERIA:

1. PARALLEL BARS WITH 1-INCH SPACING BETWEEN THE BARS UP TO THE ELEVATION OF THE WATER QUALITY DESIGN STORM;
2. PARALLEL BARS HIGHER THAN THE ELEVATION OF THE WATER QUALITY DESIGN STORM MUST BE SPACED NO GREATER THAN ONE-THIRD THE WIDTH OF THE DIAMETER OF THE ORIFICE, WITH MINIMUM SPACING BETWEEN BARS OF 1-INCH AND A MAXIMUM SPACING BETWEEN BARS OF SIX INCHES;
3. THE TRASH RACK MUST BE DESIGNED SO AS NOT TO ADVERSELY AFFECT THE HYDRAULIC PERFORMANCE OF THE OUTLET PIPE OR STRUCTURE;
4. CONSTRUCTED OF RIGID, DURABLE AND CORROSION-RESISTANT MATERIAL; AND
5. DESIGNED TO WITHSTAND PERPENDICULAR LIVE LOADING OF 300 LBS/SF.

NO.	DATE	BY	REVISION DESCRIPTION	NO.	CHK.	APP.

NEW JERSEY
TRANSCONTINENTAL GAS PIPE LINE CORPORATION
STANDARD ENVIRONMENTAL DETAIL
TR TRASH RACK
Williams GAS PIPELINE

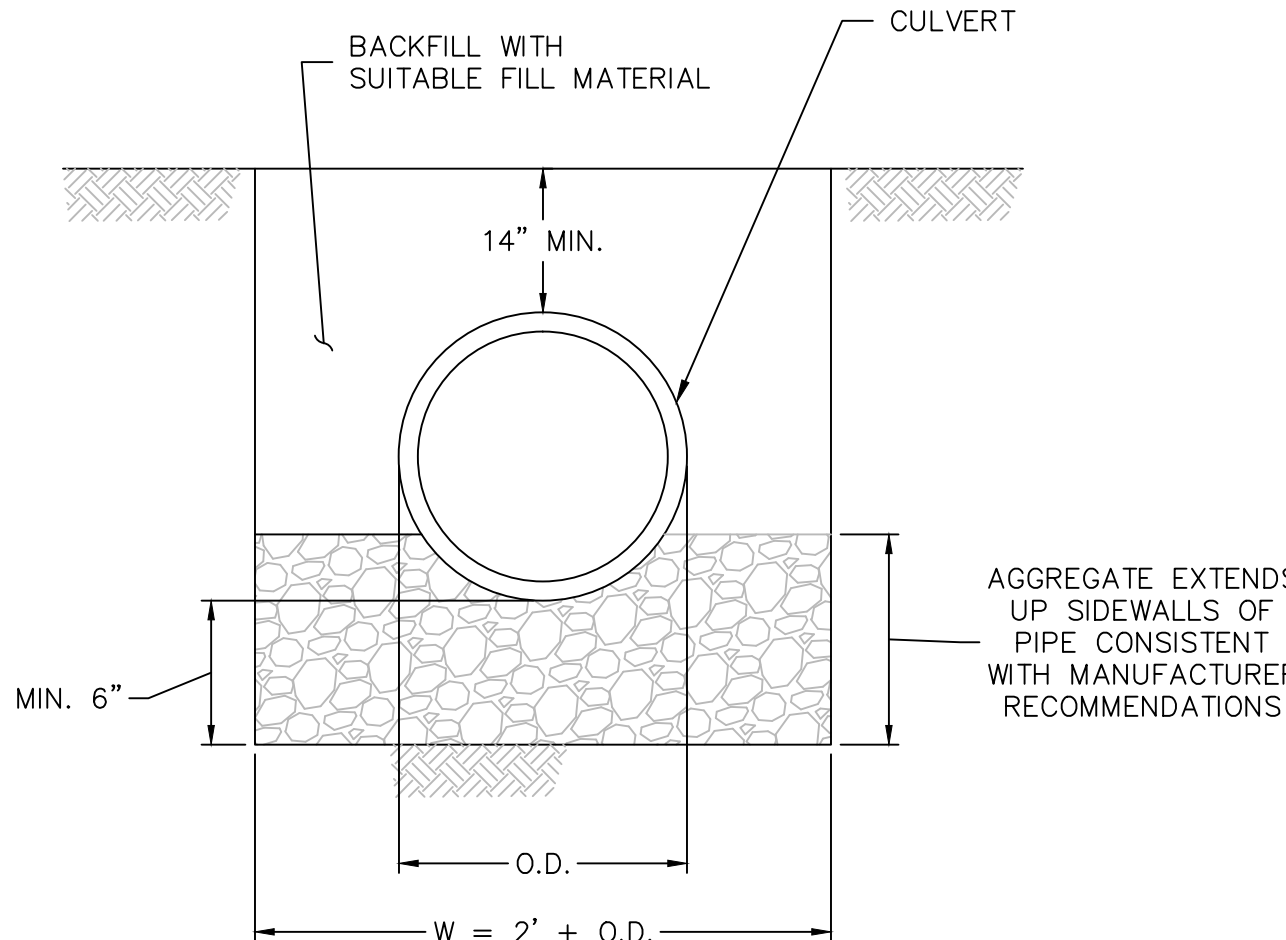

DATE	BY	REVISION DESCRIPTION

NEW JERSEY
TRANSCONTINENTAL GAS PIPE LINE CORPORATION
PROJECT SPECIFIC DETAIL
PIPE BEDDING
Williams GAS PIPELINE


KEVIN MCKEON, P.E.
NEW JERSEY
PROFESSIONAL ENGINEER NO GE32586

NO.	DATE	BY	DESCRIPTION	W.D. NO.	CHK.	APP.
0	06/15/17	GMS	SUBMITTED TO SOMERSET UNION SCD	1185732	PPH	KDM
1	08/11/17	GMS	REVISED NJDEP AND SCD SUBMISSION	1185732	PPH	KDM
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7	04/22/19	PPH	SUPPLEMENTAL INFORMATION	1185732	PPH	KDM
8	05/03/19	PPH	REVISED BASIN GRADING	1185732	PPH	KDM
9	06/07/19	PPH	REVISED BASIN GRADING	1185732	GMS	KDM
10	06/24/19	PPH	LOD REDUCTION IN WETLAND TRANSITION	1185732	GMS	KDM
11	01/15/20	PPH	NJDEP SUBMISSION	1185732	TPF	KDM

TRANSCONTINENTAL GAS PIPE LINE COMPANY, LLC. POST CONSTRUCTION STORMWATER MANAGEMENT PLAN NORTHEAST SUPPLY ENHANCEMENT PROJECT COMPRESSOR STATION NO. 206 - TRAP ROCK ACCESS ROAD DETAILS (SHEET 2 OF 4) FRANKLIN TOWNSHIP, SOMERSET COUNTY, NJ				Williams GAS PIPELINE	
DRAWN BY: GMS	DATE: 06/15/17	ISSUED FOR BID: TBD	SCALE:		
CHECKED BY: PPH	DATE: 06/15/17	ISSUED FOR CONSTRUCTION: TBD	REVISION: 11		
APPROVED BY: KDM	DATE: 06/15/17	DRAWING NUMBER:	SHEET 9 OF 13		

AECOM
625 WEST RIDGE PIKE, SUITE E-100
CONSHOHOCKEN, PA 19428
(610) 832-3500

Drawn By: & Date/Time: hoase, Jan 10, 2020 - 12:40pm
 Drawing Location & Name: S:\Projects\ENV\60527393_NESE_CS206\900-CAD-910-CAD-20-PCSM-SHEETS\08-11 - PCSM Detail Sheets.dwg

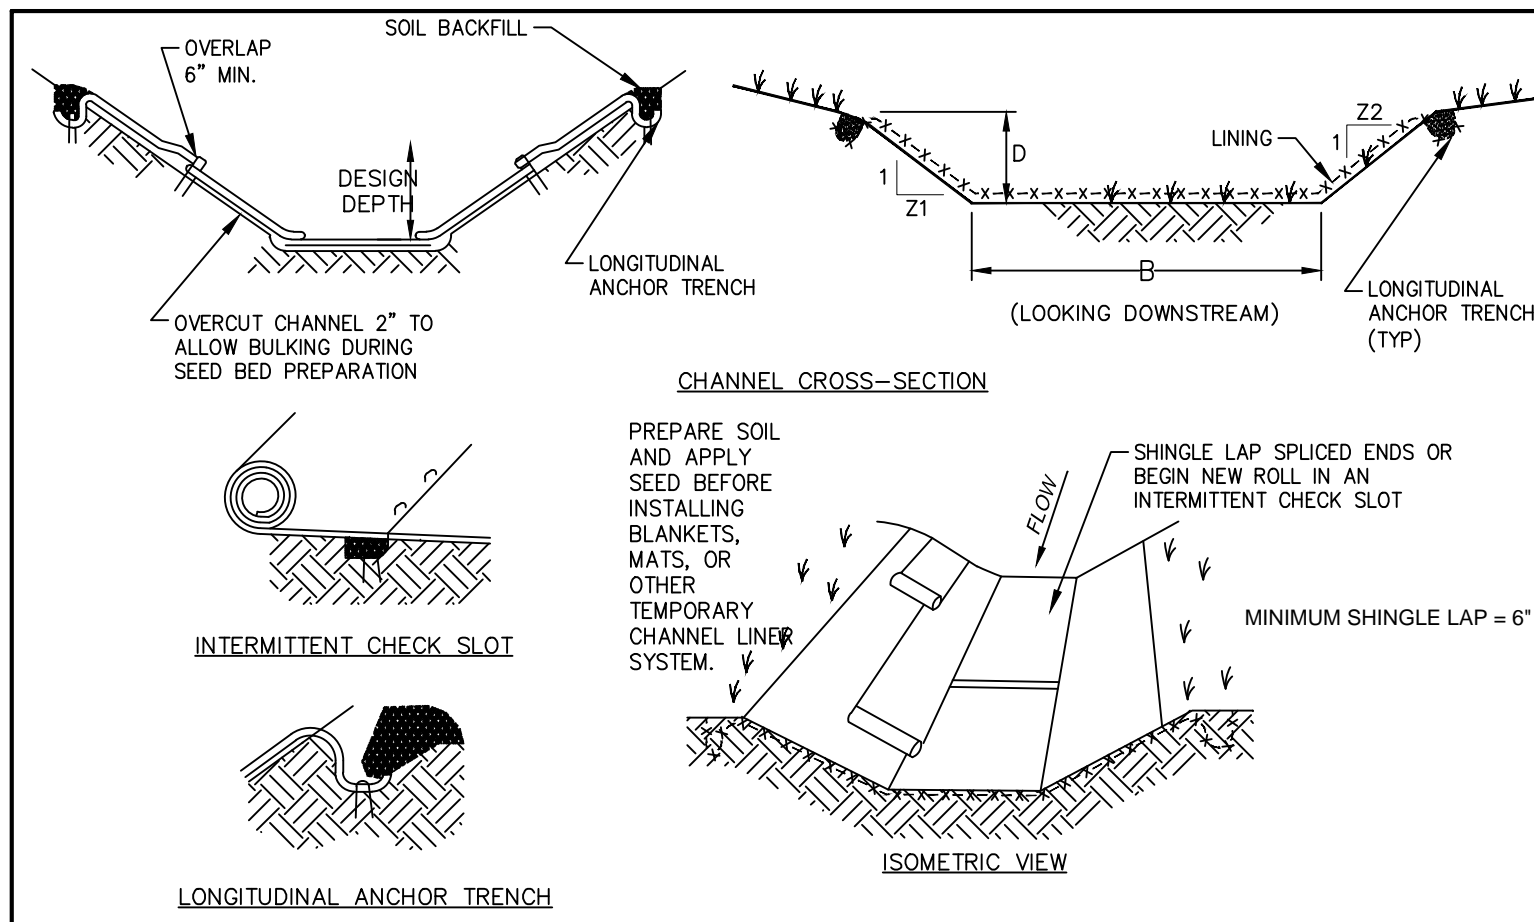


CHANNEL	BOTTOM WIDTH B (FT)	DEPTH D (FT)	TOP WIDTH W (FT)	Z1 (FT)	Z2 (FT)	LINING
1	2	1.0	10	4	4	SC250/VEG
2	2	1.0	10	4	4	SC250/VEG
3	2	1.5	14	4	4	SC250/VEG
4	2	1.5	8	2	2	SC250/VEG
5	2	1.5	14	4	4	SC250/VEG
6	2	1.5	14	4	4	SC250/VEG
7A	2	1.5	14	4	4	SC250/VEG
10	2	1.5	14	4	4	SC250/VEG
11	2	1.5	14	4	4	SC250/VEG
12	2	1.5	14	4	4	SC250/VEG
15	2	1.5	8	2	2	SC250/VEG

NOTES:

- SEE MANUFACTURER'S INSTALLATION DETAIL FOR STAPLE PATTERNS, AND VEGETATION STABILIZATION SPECIFICATIONS FOR SOIL AMENDMENTS, SEED MIXTURES, AND MULCHING INFORMATION.
- ANCHOR TRENCHES SHALL BE INSTALLED AT BEGINNING AND END OF CHANNEL IN THE SAME MANNER AS LONGITUDINAL ANCHOR TRENCHES.
- CHANNEL DIMENSIONS SHALL BE CONSTANTLY MAINTAINED. CHANNEL SHALL BE CLEANED WHENEVER TOTAL CHANNEL DEPTH IS REDUCED BY 25% AT ANY LOCATION. SEDIMENT DEPOSITS SHALL BE REMOVED WITHIN 24 HOURS OF DISCOVERY OR AS SOON AS SOIL CONDITIONS PERMIT ACCESS TO CHANNEL WITHOUT FURTHER DAMAGE. DAMAGED LINING SHALL BE REPAIRED OR REPLACED WITHIN 48 HOURS OF DISCOVERY.
- NO MORE THAN ONE THIRD OF THE SHOOT (GRASS LEAF) SHALL BE REMOVED IN ANY MOWING. GRASS HEIGHT SHALL BE MAINTAINED BETWEEN 2 AND 3 INCHES UNLESS OTHERWISE SPECIFIED. EXCESS VEGETATION SHALL BE REMOVED FROM PERMANENT CHANNELS TO ENSURE SUFFICIENT CHANNEL CAPACITY.
- NORTH AMERICAN GREEN (NAG) SC-250 EROSION CONTROL MATTING (OR EQUIVALENT) SHALL BE USED CHANNEL LINING.

NEW JERSEY

NO.	DATE	BY	REVISION DESCRIPTION	NO.	CHK	APP.	TRANSCONTINENTAL GAS PIPE LINE CORPORATION STANDARD ENVIRONMENTAL DETAIL	
							VC VEGETATED CHANNEL	

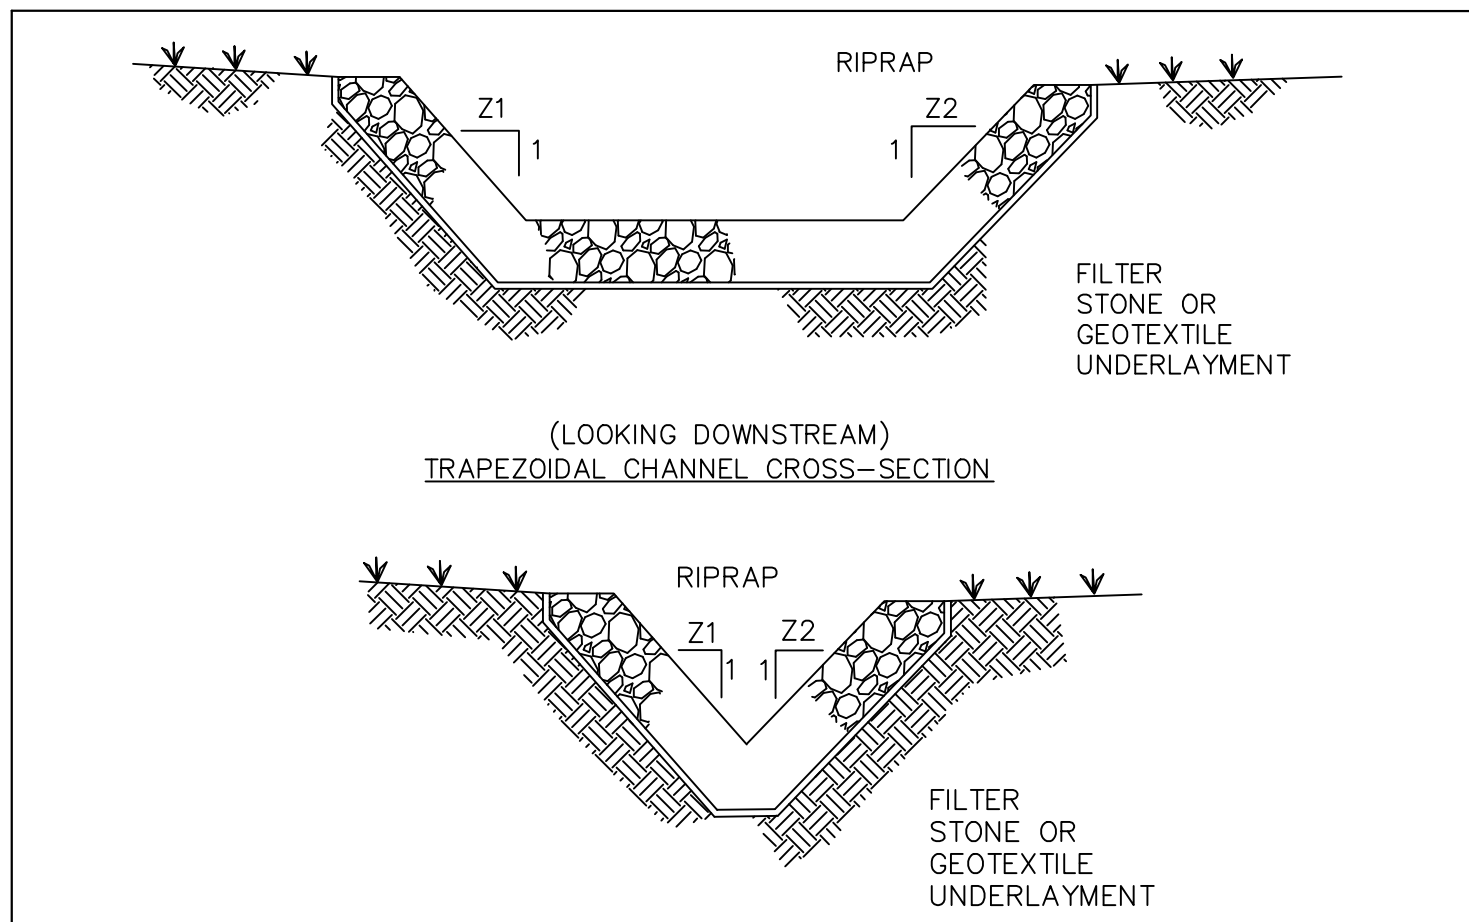

NOTES:

FILTER STONE UNDERLAYMENT FOR BED SLOPES ≥ 0.10 FT/FT (10%) SHALL BE USED.

CHANNEL DIMENSIONS ARE FOR THE COMPLETED CHANNEL AFTER ROCK PLACEMENT. CHANNEL MUST BE OVER-EXCAVATED A SUFFICIENT AMOUNT TO ALLOW FOR THE VOLUME OF ROCK PLACED WITHIN THE CHANNEL WHILE PROVIDING THE SPECIFIED FINISHED DIMENSIONS.

CHANNEL DIMENSIONS SHALL BE CONSTANTLY MAINTAINED. CHANNEL SHALL BE CLEANED WHENEVER TOTAL CHANNEL DEPTH IS REDUCED BY 25% AT ANY LOCATION. SEDIMENT DEPOSITS SHALL BE REMOVED WITHIN 24 HOURS OF DISCOVERY OR AS SOON AS SOIL CONDITIONS PERMIT ACCESS TO CHANNEL WITHOUT FURTHER DAMAGE.


DAMAGED LINING SHALL BE REPAIRED OR REPLACED WITHIN 48 HOURS OF DISCOVERY.

THE MINIMUM ROCK THICKNESS (t) SHALL BE 1.5 TIMES THE MAX ROCK SIZE.

CHANNEL	SHAPE (TRAPEZOIDAL OR TRIANGULAR)	BOTTOM WIDTH B (FT)	DEPTH D (FT)	TOP WIDTH W (FT)	Z1 (FT)	Z2 (FT)	LINING	THICKNESS t (IN)
7B	TRAPEZOIDAL	2	10.0	37	4	4	R-3	6
8	TRIANGULAR	0	1.5	15	5	5	R-3	6
9	TRIANGULAR	0	1.5	15	5	5	R-3	6
13	TRAPEZOIDAL	2	2.0	18	4	4	R-3	6
14	TRAPEZOIDAL	20	1.0	36	8	8	R-4	12


NEW JERSEY

NO.	DATE	BY	REVISION DESCRIPTION	NO.	CHK	APP.	TRANSCONTINENTAL GAS PIPE LINE CORPORATION PROJECT SPECIFIC DETAIL	
							RIPRAP CHANNEL	

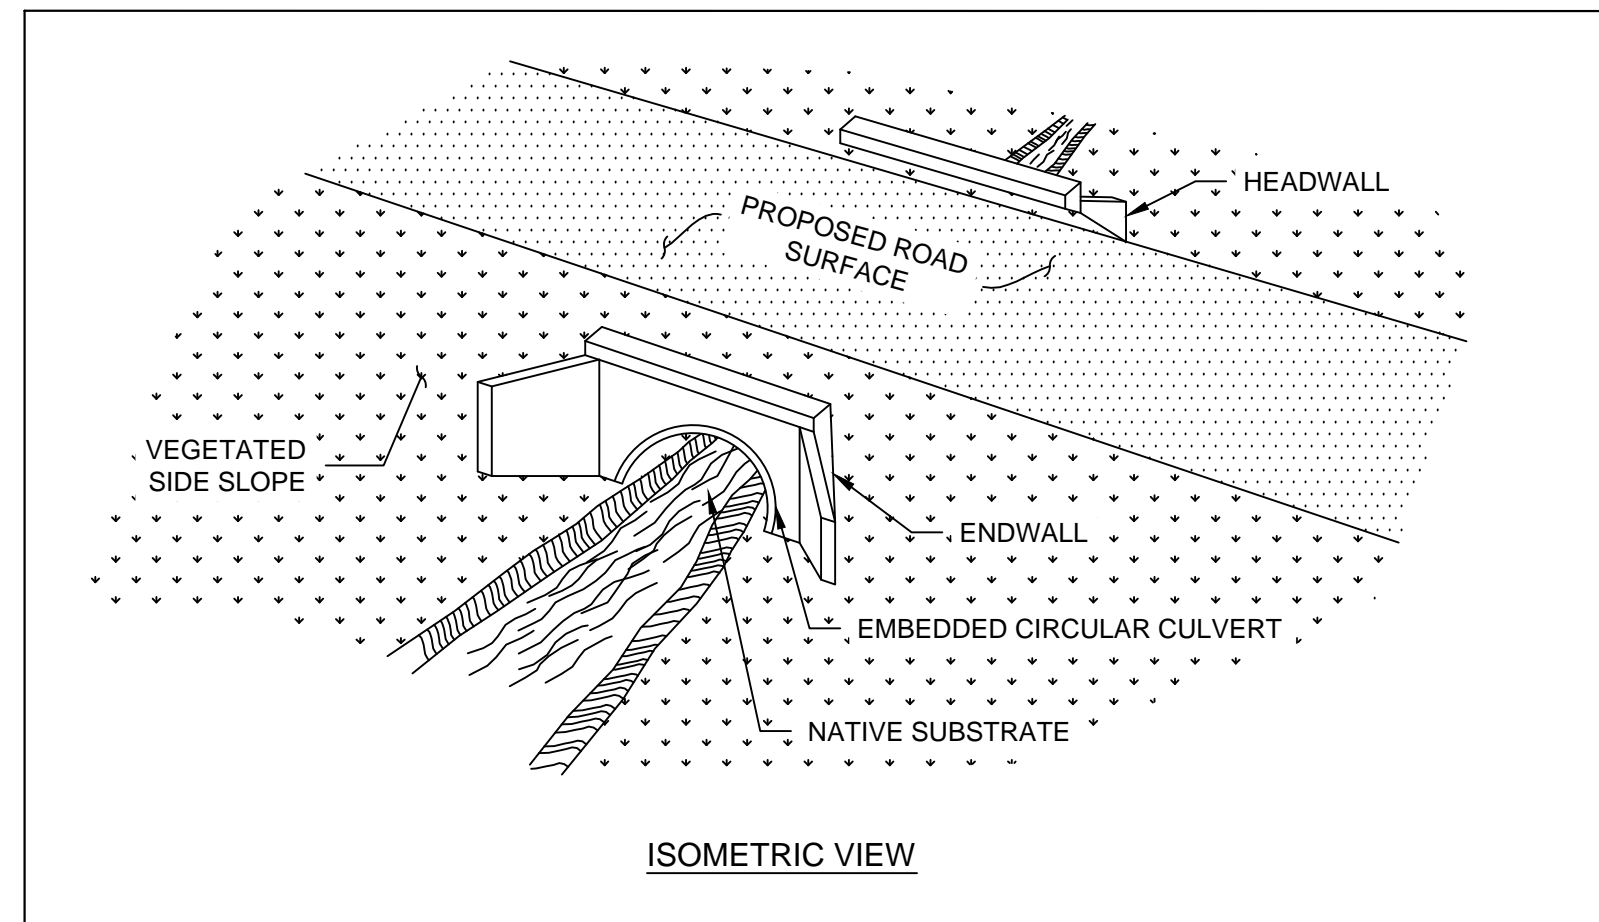

NOTES:


- PROPOSED EMBEDDED CIRCULAR CULVERTS SHALL COMPLETELY SPAN THE WIDTH OF THE STREAM CHANNEL.
- CONTRACTOR SHALL REPLICATE NATURAL STREAM MATERIAL (I.E. NATIVE SUBSTRATE) AND MATCH OR EXCEED THE DIMENSIONS OF THE EXISTING CHANNEL AT THE INLET AND OUTLET OF THE CULVERT.
- HEADWALL & ENDWALL SHALL BE ATTACHED TO CULVERT PRIOR TO EMBEDMENT.
- CONTRACTOR SHALL INSTALL RIPRAP APRON (REFER TO DETAIL) AND MIX EXISTING STREAMBED MATERIAL (I.E. NATIVE SUBSTRATE) TO REPLICATE PRE-CONSTRUCTION CONDITIONS.

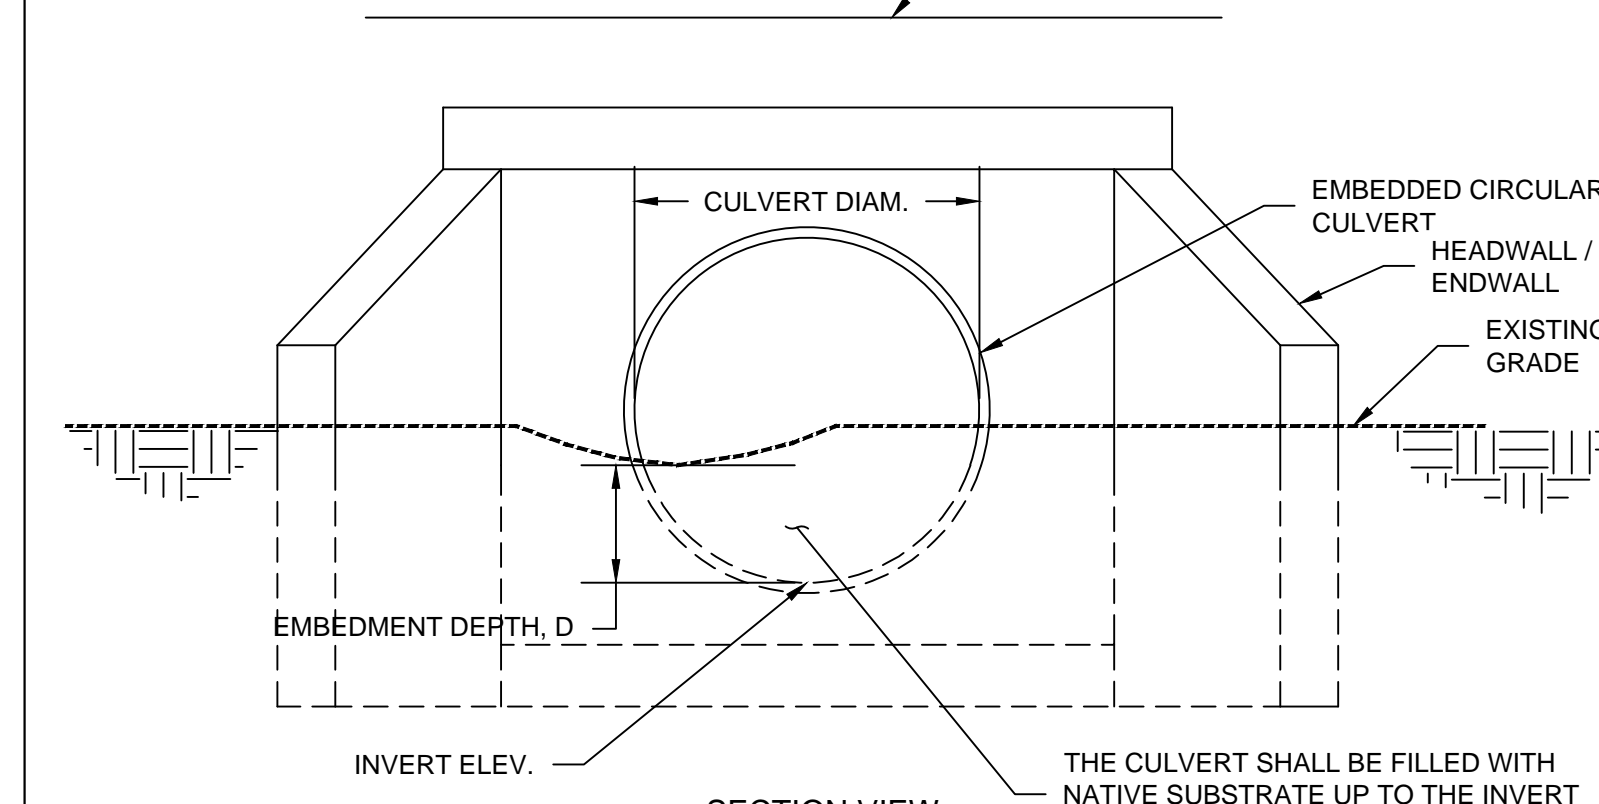

CULVERT NO.	CULVERT DIAMETER (IN.)	CULVERT LENGTH, L (FT)	EMBEDMENT DEPTH, D (FT.)	INVERT IN (ELEV.)	INVERT OUT (ELEV.)	PIPE SLOPE (%)	MATERIAL
1	48	65	2	261.0	258.0	4.6	RCP
2	42	57	2	263.0	262.0	1.8	RCP
7	42	71	2	262.0	261.0	1.4	RCP
8	42	61	2	262.0	260.0	3.3	RCP


NEW JERSEY

NO.	DATE	BY	REVISION DESCRIPTION	NO.	CHK	APP.	TRANSCONTINENTAL GAS PIPE LINE CORPORATION PROJECT SPECIFIC DETAIL	
							CULVERT FOR STREAM CROSSINGS	

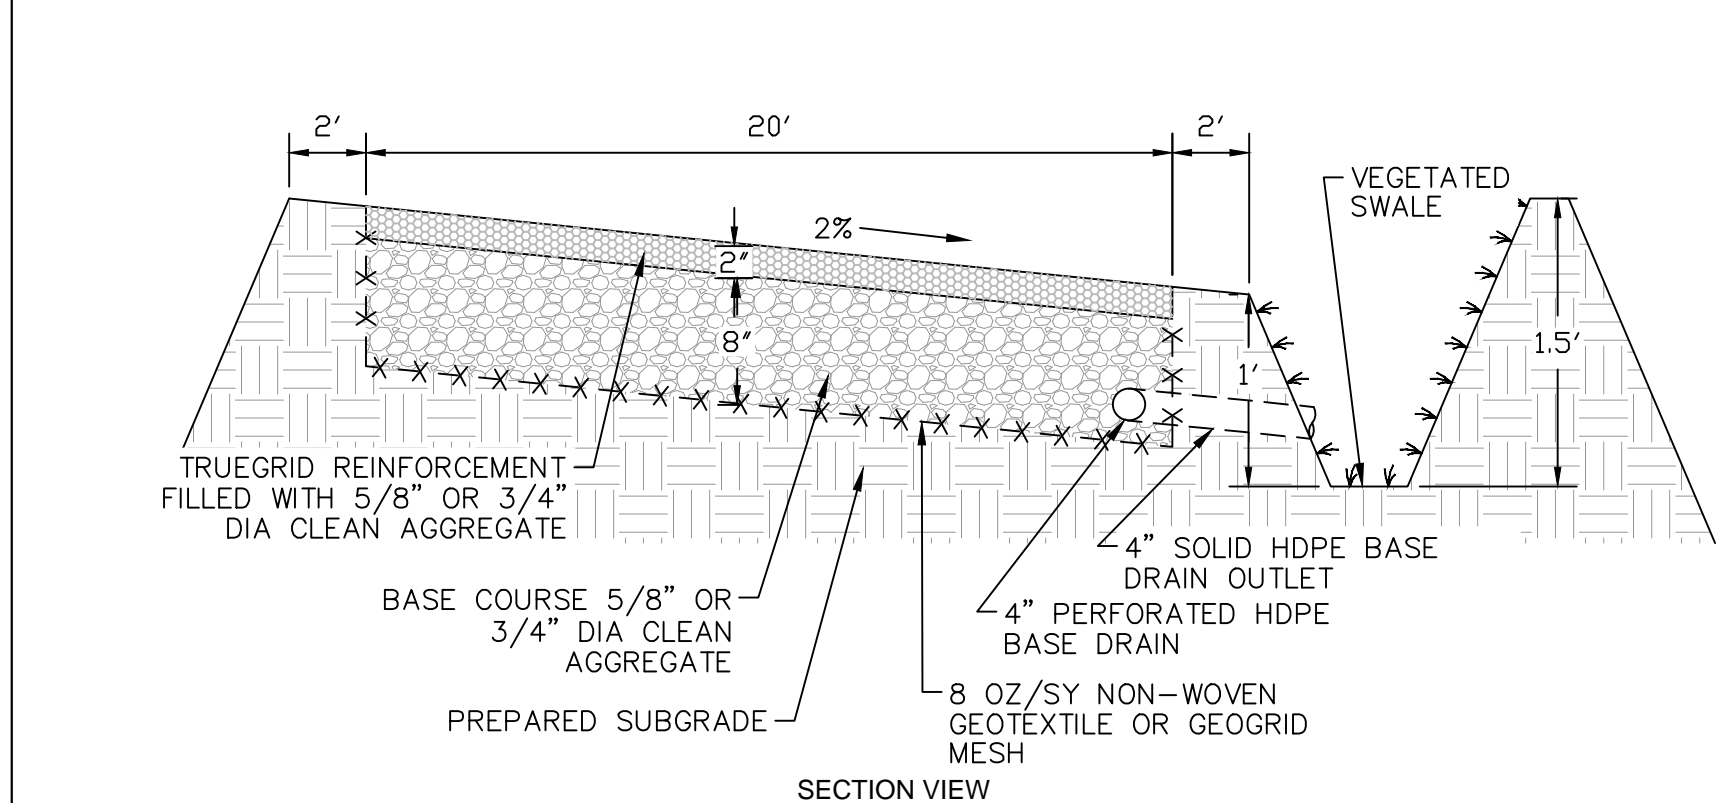

NOTES:

- ONCE SUBGRADE HAS BEEN PREPARED, INSTALL GEOTEXTILE OR GEOGRID MESH.
- INSTALL BASE DRAIN AND BACKFILL BASE COURSE MATERIAL IN 4-INCH LIFTS, LEVELED AND COMPACTED TO LOCK IN ANGULAR STONE.
- INSTALL TRUEGRID REINFORCEMENT UNITS BY PLACING CELLS FACE UP, RE-CONFIGURED AND CUT AS NECESSARY TO MEET THE PROJECT GEOMETRY.
- BACKFILL SURFACE COURSE MATERIAL BY BACK DUMPING DIRECTLY FROM DUMP TRUCKS OR FROM BUCKETS MOUNTED TO TRACTORS. HAND SHOVELING IS ALSO ACCEPTABLE. SPREAD MATERIAL USING STEER LOADERS, POWER BROOMS, BLADES, FLAT-BOTTOMED SHOVELS, AND/OR WIDE "ASPHALT RAKES" TO FILL THE CELLS. ONCE CELLS ARE AT CAPACITY, COMPACT AGGREGATE WITH A ROLLER OR VIBRATING PLATE.
- ALL AGGREGATE SHALL BE UNIFORMLY GRADED AND CLEAN PRIOR TO INSTALLATION.
- REFER TO PLANS FOR VEGETATED SWALE LOCATIONS AND DETAILS FOR LINING AND DIMENSION REQUIREMENTS.
- BASE DRAIN SHALL DAYLIGHT A MINIMUM OF 200' FEET OF LINEAR ROAD AT A MINIMUM SLOPE OF 0.5%

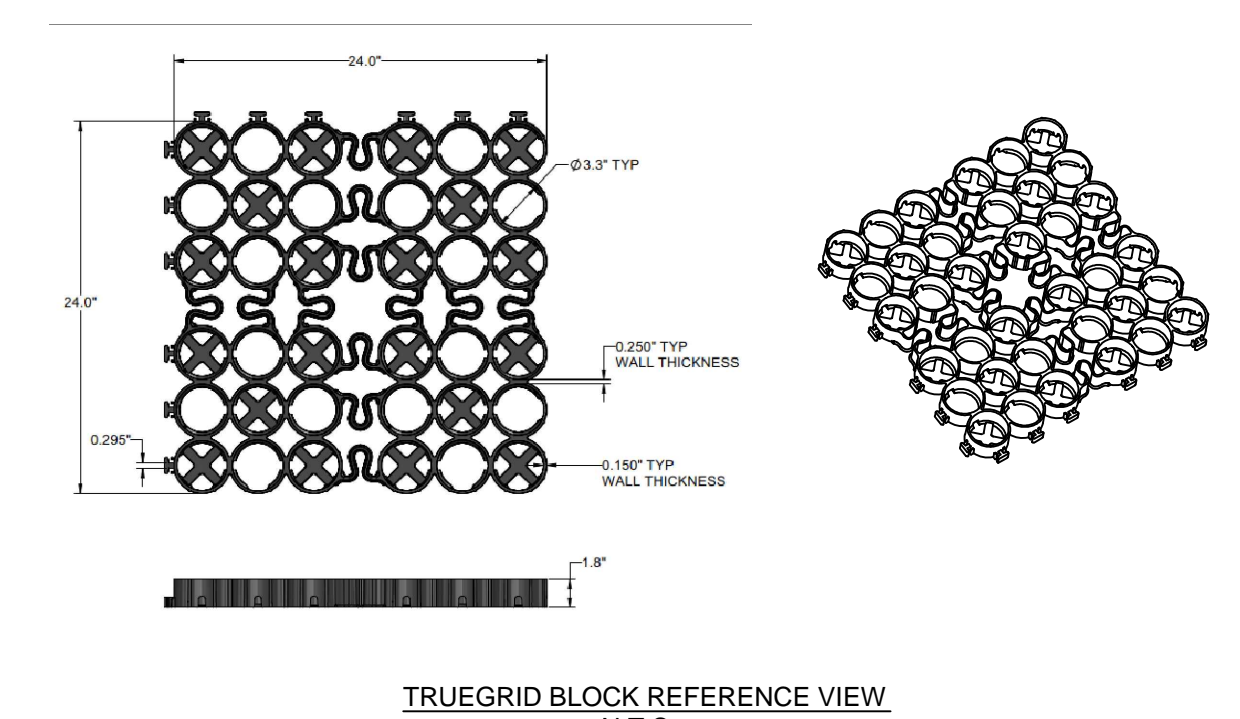

TRUEGRID BLOCK REFERENCE VIEW
N.T.S.

PREASSEMBLED & DELIVERED IN 4' X 4' SHEET. RECONFIGURE AS NEEDED. NO EXTRA TOOLING OR ACCESSORIES REQUIRED.


NEW JERSEY

DATE	BY	REVISION DESCRIPTION	TRANSCONTINENTAL GAS PIPE LINE CORPORATION PROJECT SPECIFIC DETAIL	
			REINFORCED GRAVEL ACCESS ROAD	

AECOM
625 WEST RIDGE PIKE, SUITE E-100
CONSHOHOCKEN, PA 19428
(610) 832-3500

KEVIN MCKEON, P.E.
NEW JERSEY
PROFESSIONAL ENGINEER NO. GE32586

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11	01/15/20	PPH	NJDEP SUBMISSION	1185732	TPF	KDM

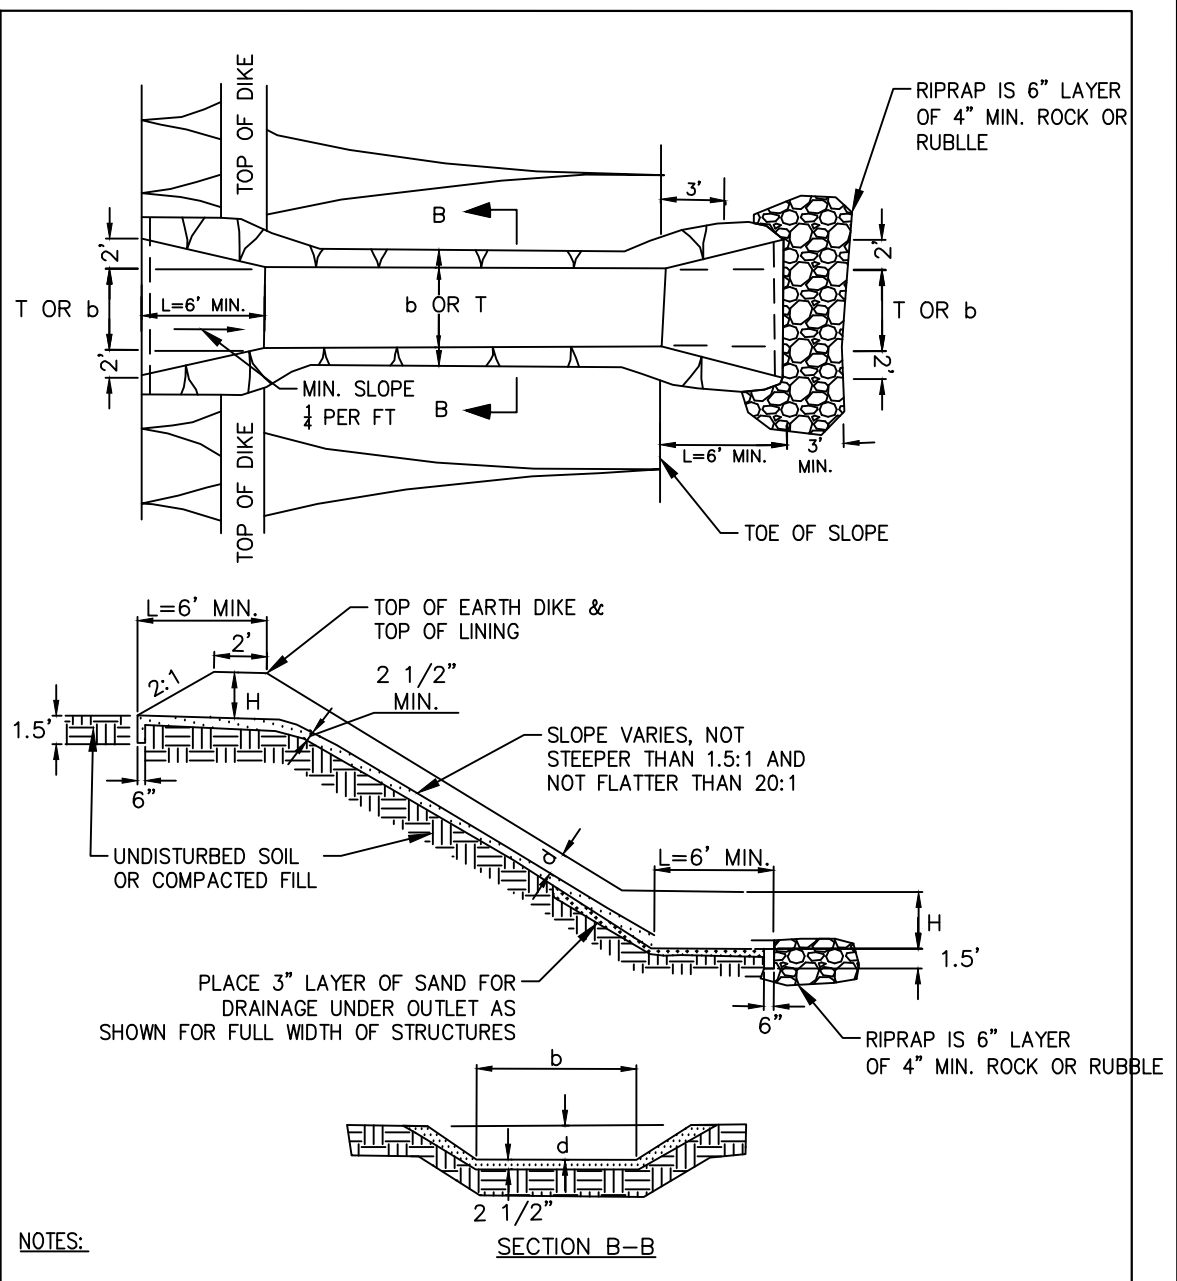

NOTES:

- LINING SHALL BE RIPRAP.
- SOME TYPE OF ENERGY DISSIPATOR, SUCH AS THE ONE SHOWN ABOVE, MUST BE USED TO PREVENT EROSION AT THE OUTLET.

RIPRAP SLOPE PROTECTION	BOTTOM WIDTH b (FT)	HEIGHT H (FT)	DEPTH d (FT)	LINING
1	25	2.0	0.75	R-3

NEW JERSEY

NO.	DATE	BY	REVISION DESCRIPTION	NO.	CHK	APP.	TRANSCONTINENTAL GAS PIPE LINE CORPORATION PROJECT SPECIFIC DETAIL	
							RIPRAP SLOPE PROTECTION	

NEW JERSEY



TRANSCONTINENTAL GAS PIPE LINE COMPANY, LLC.
POST CONSTRUCTION STORMWATER MANAGEMENT PLAN
NORTHEAST SUPPLY ENHANCEMENT PROJECT
COMPRESSOR STATION NO. 206 - TRAP ROCK ACCESS ROAD
DETAILS (SHEET 4 OF 4)
FRANKLIN TOWNSHIP, SOMERSET COUNTY, NJ

DRAWN BY: GMS	DATE: 06/15/17	ISSUED FOR BID: TBD	SCALE:
CHECKED BY: PPH	DATE: 06/15/17	ISSUED FOR CONSTRUCTION: TBD	REVISION: 11
APPROVED BY: KDM	DATE: 06/15/17	DRAWING NUMBER:	SHEET 11 OF 13

LEGEND

- EXISTING FEATURES**
- 265 — EXISTING MAJOR CONTOUR
 - - - EXISTING MINOR CONTOUR
 - STREAM CENTERLINE
 - WETLAND
 - EXISTING TREE LINE
 - PARCEL LINE
 - EXISTING ACCESS ROADS
 - EXISTING FENCE
 - OHE — EXISTING OVERHEAD POWER LINE
 - EXISTING PIPELINE
 - EXISTING RIGHT OF WAY

- PROPOSED FEATURES**
- LOD — LIMIT OF DISTURBANCE
 - PROPOSED CONTOUR MAJOR
 - PROPOSED CONTOUR MINOR
 - GAS — PROPOSED PIPELINE
 - - - CULVERT
 - RIP RAP APRON
 - PROPOSED FENCE
 - PROPOSED TREE LINE
 - PROPOSED GRAVEL
 - PROPOSED CONCRETE
 - RIPRAP SLOPE PROTECTION
 - PROPOSED BRUSH SEED MIX
 - TP-8 — SOIL TEST LOCATION

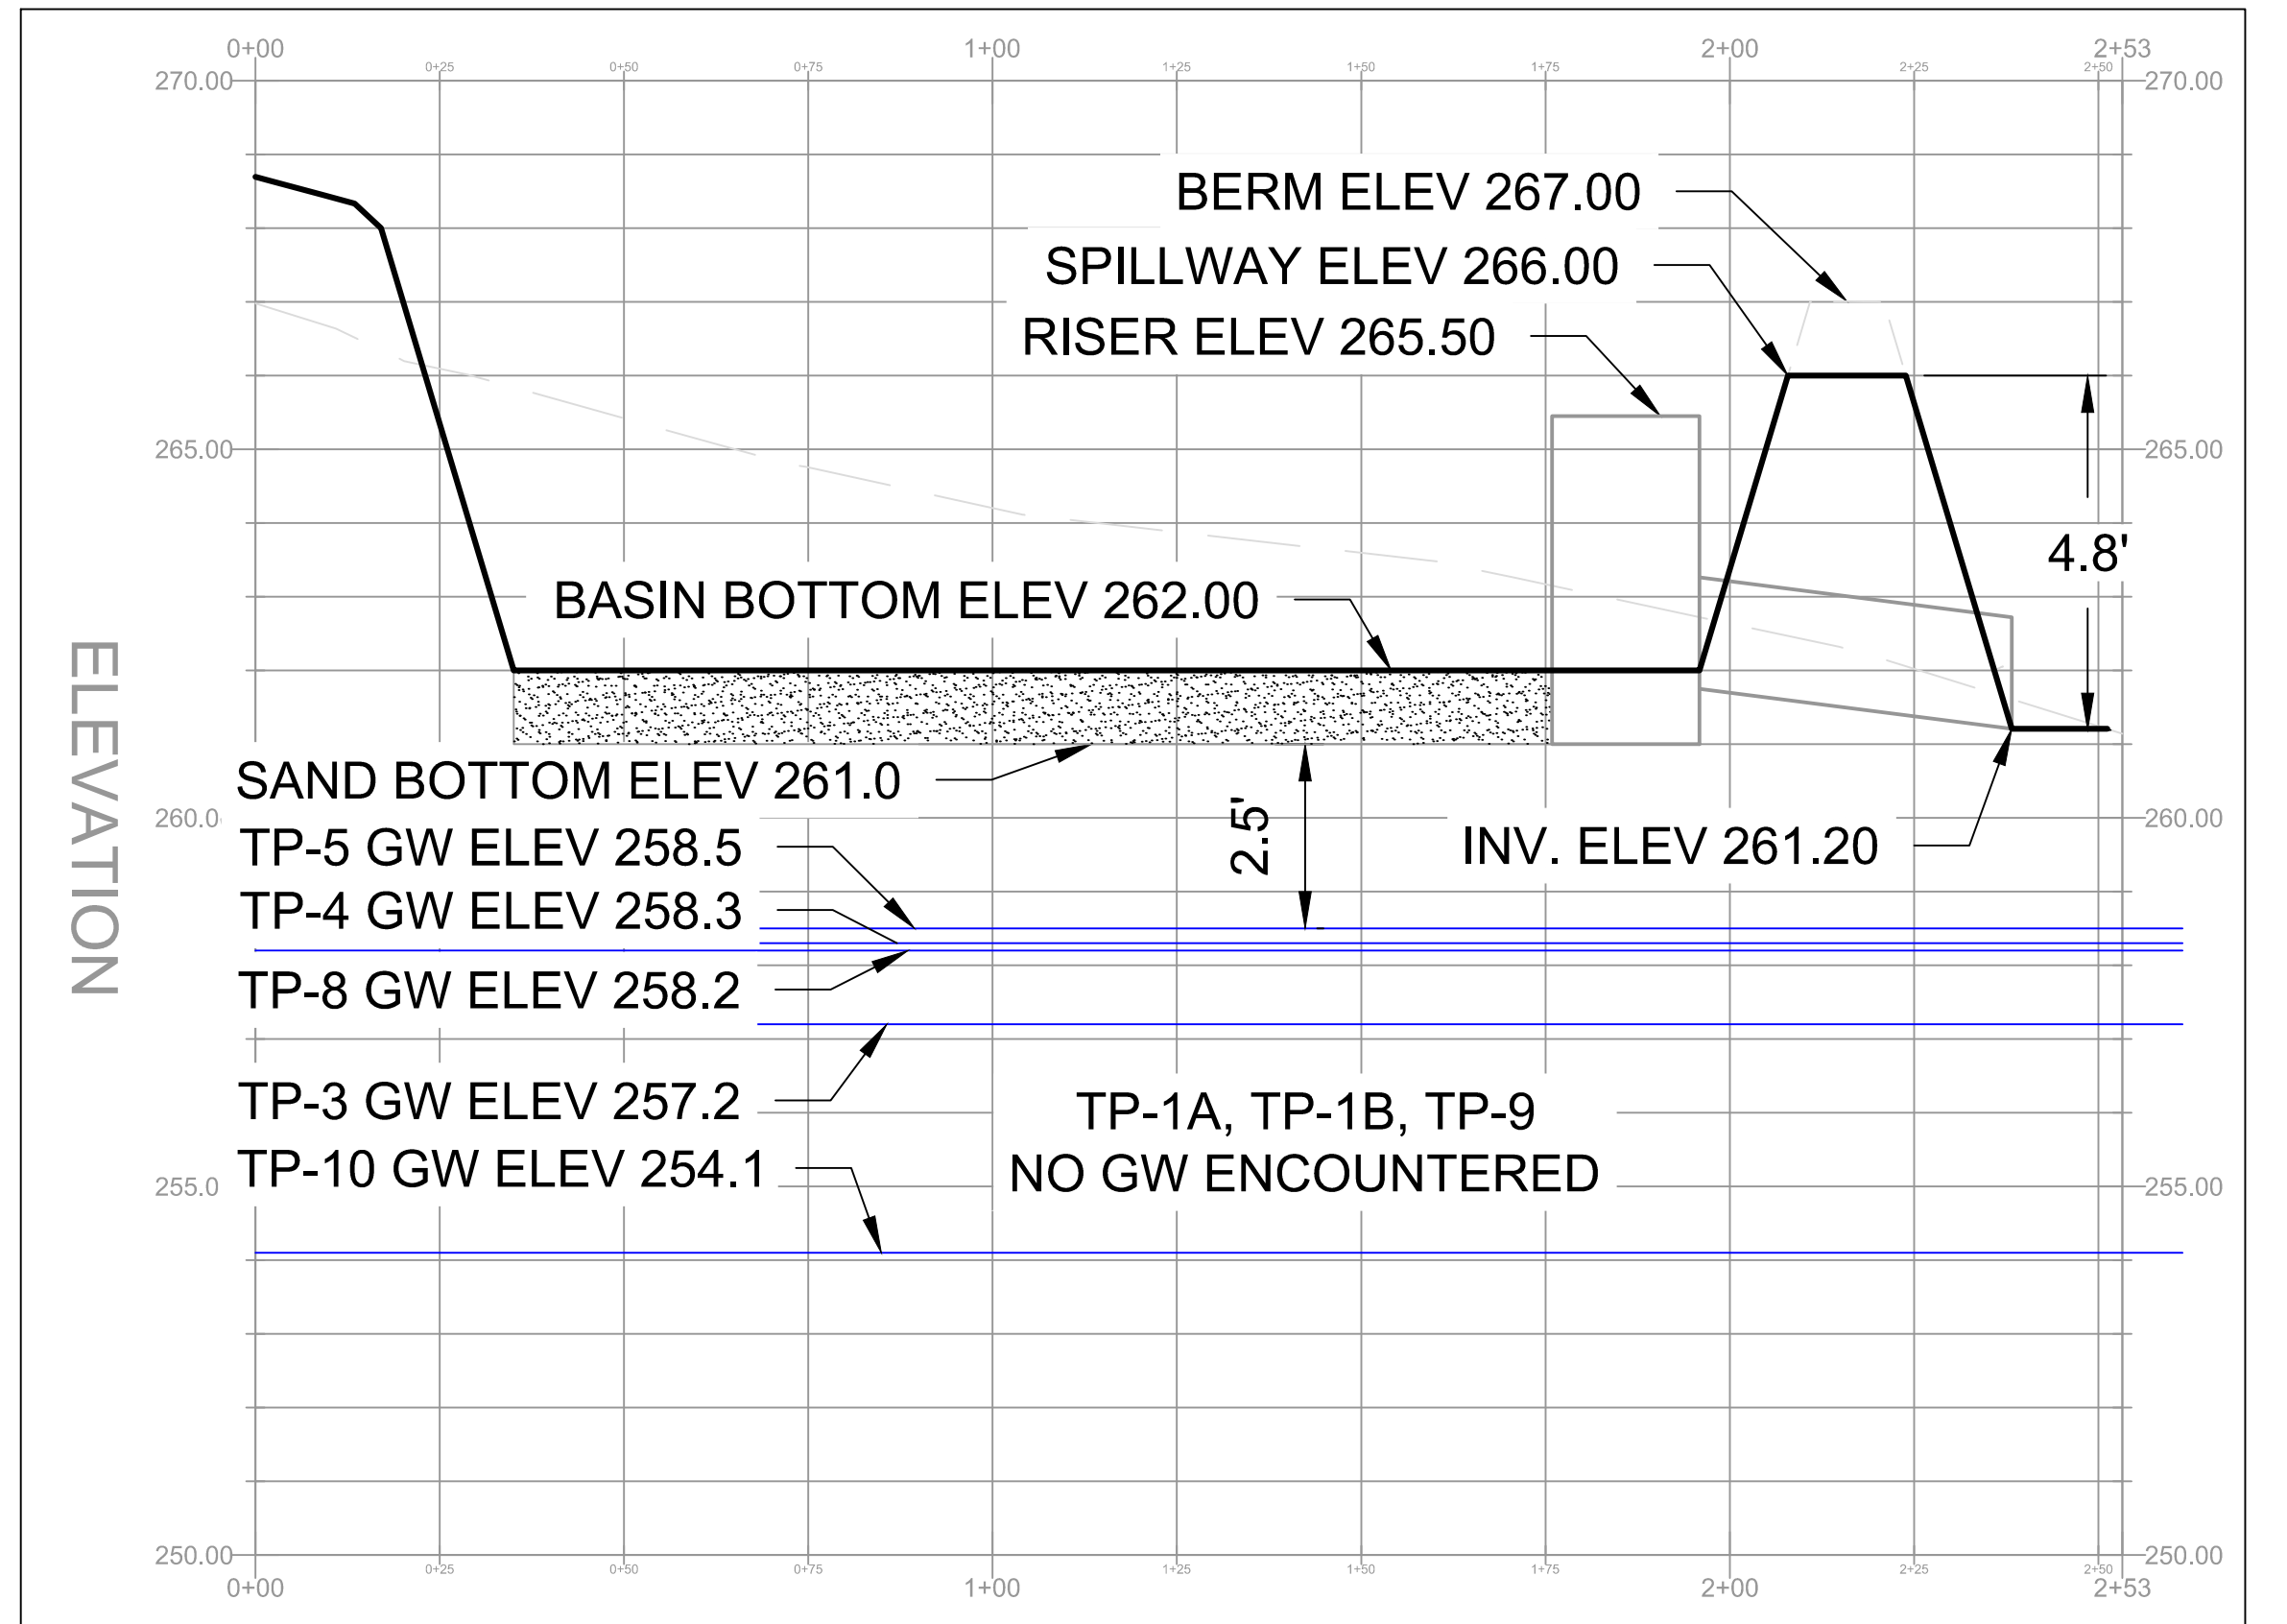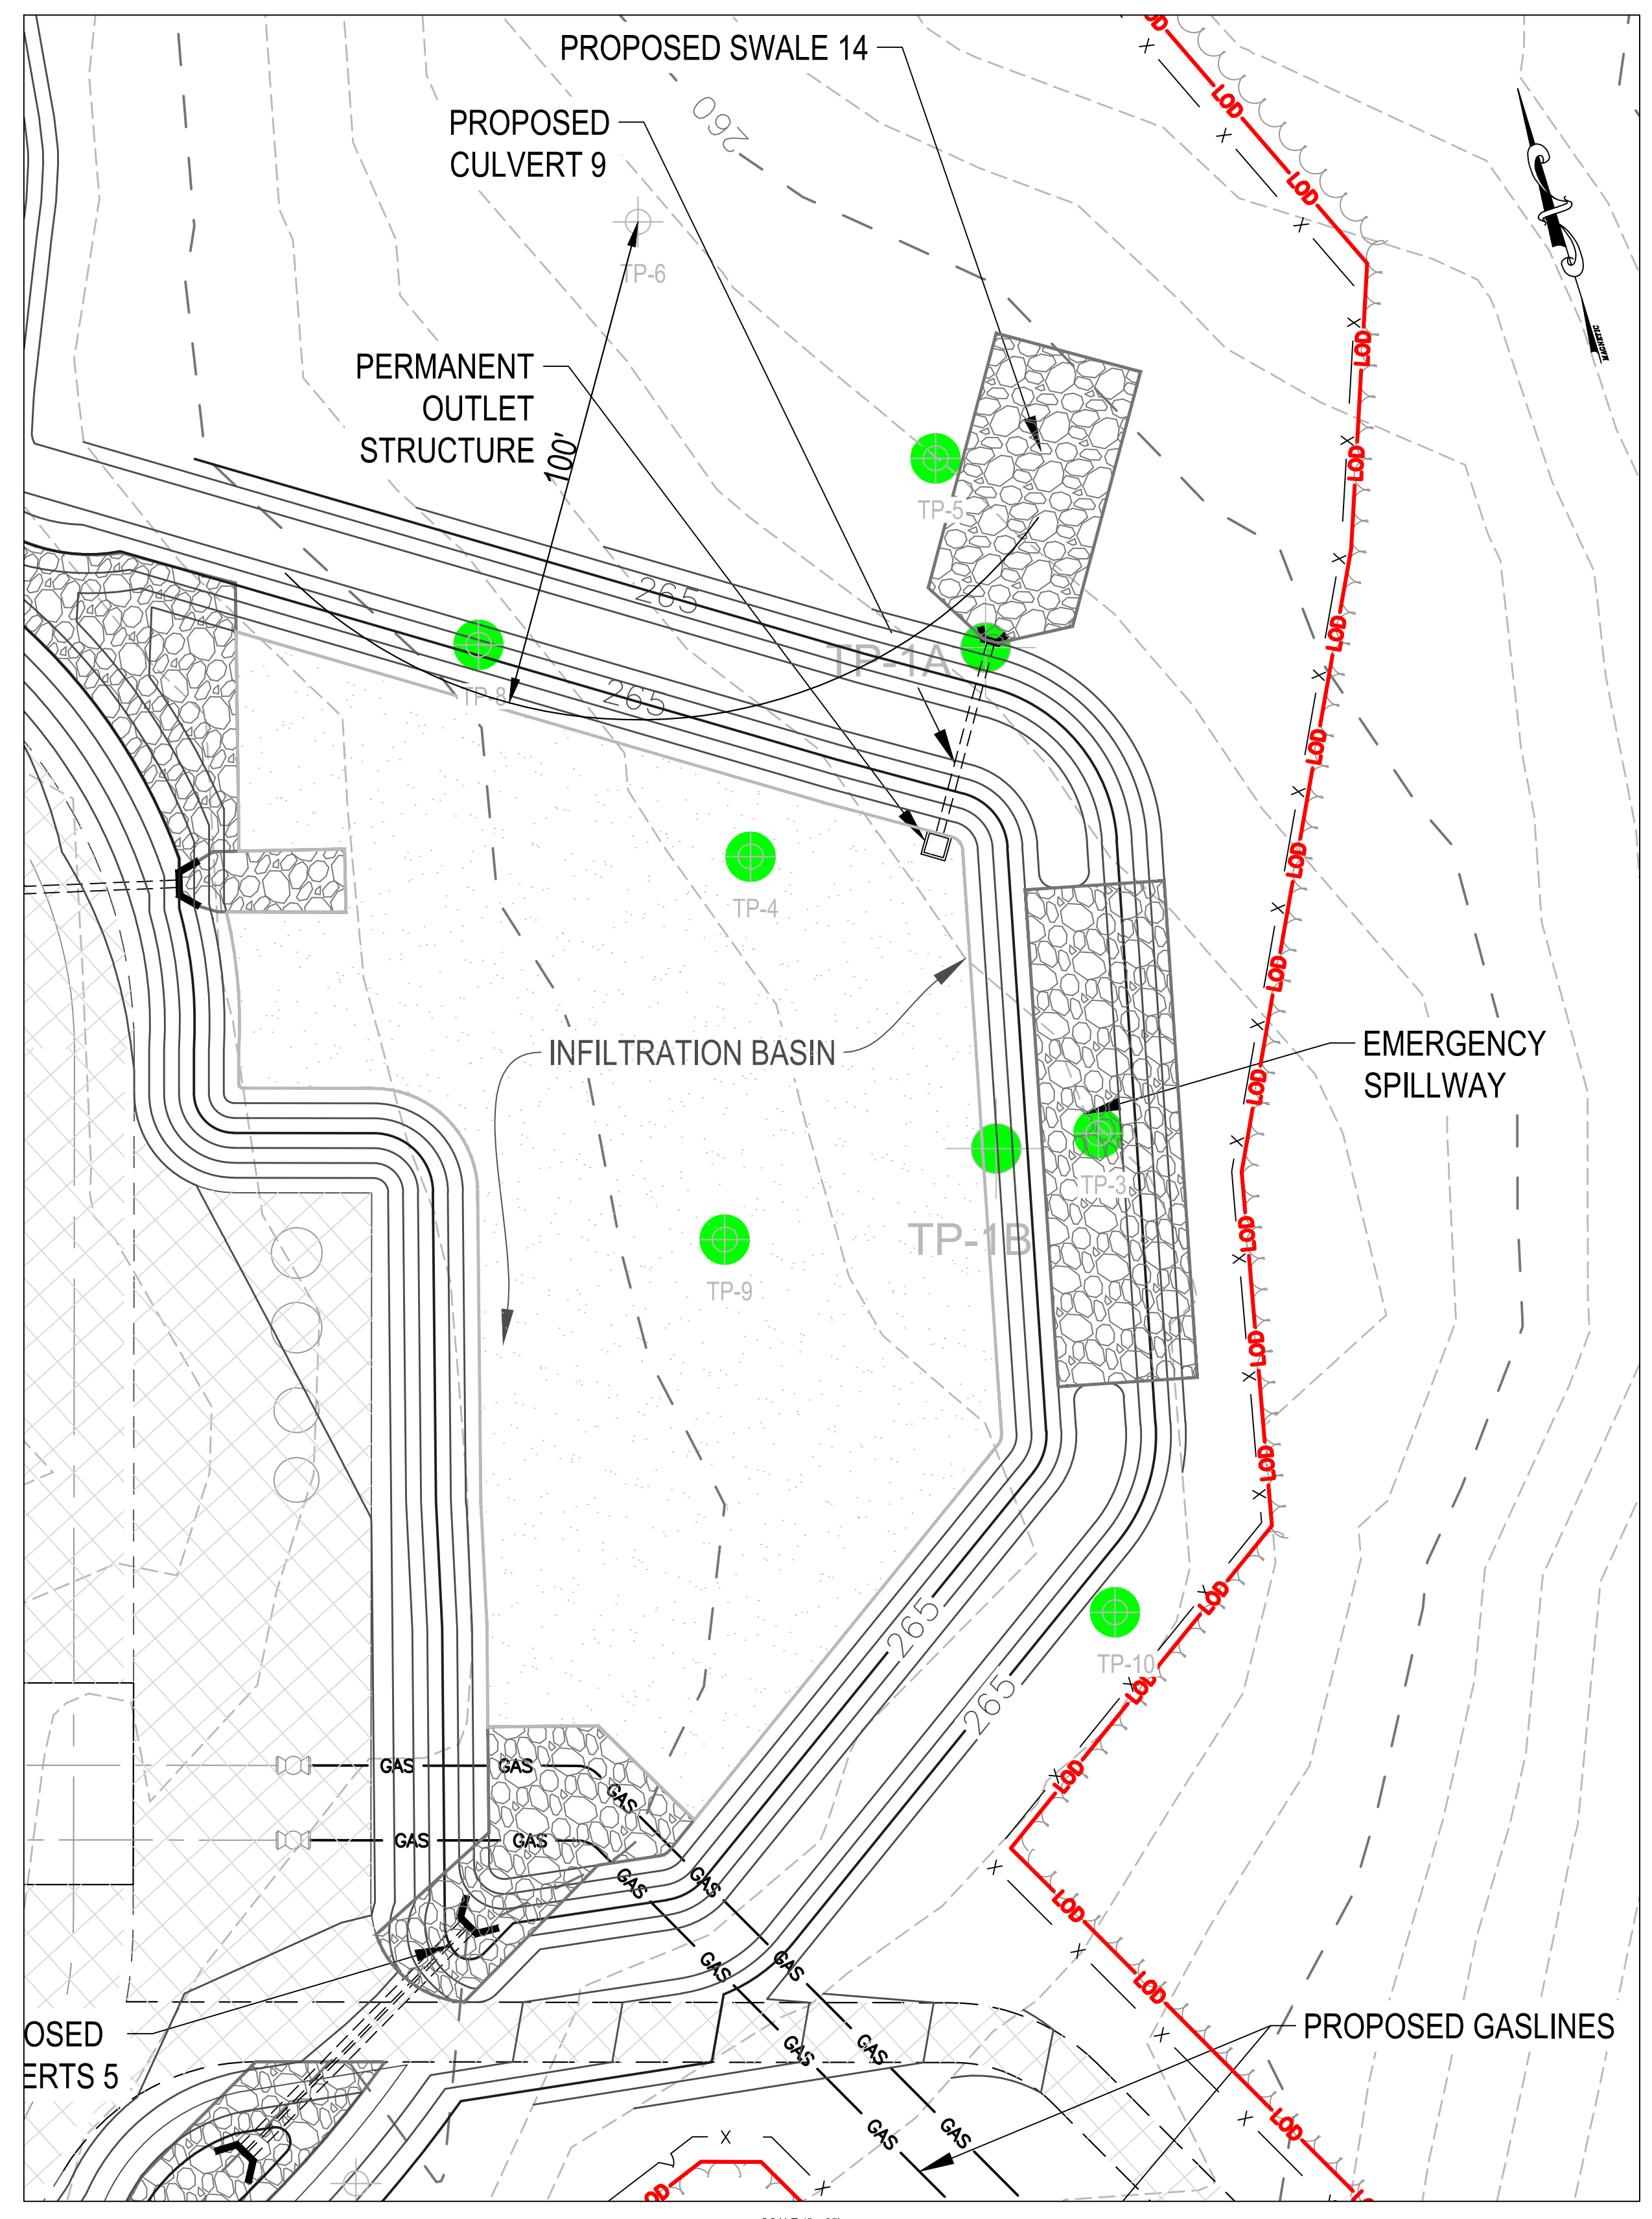

Soil Test Summary

Location I.D.	Test Type 1,2	Existing Grade Elevation (ft)	Test Pit/Bore Bottom		Bedrock		Groundwater	
			Depth (ft)	Elevation (ft)	Depth (ft)	Elevation (ft)	Depth (ft)	Elevation (ft)
TP-1A	TP w/IT	261.7	6.0	255.7	N/E 3		N/E 3	
TP-1B	TP w/IT	263.3	8.0	255.3	N/E 3		N/E 3	
TP-3	B w/MW	263.0	15.0	248.0	N/E 3		5.8	257.2
TP-4	B w/MW	263.6	15.0	248.6	N/E 3		5.3	258.3
TP-5	B w/MW	261.0	15.0	246.0	15.0	246.0	2.5	258.5
TP-8	TP w/IT	264.5	6.5	258.0	6.5	258.0	6.3	258.2
TP-9	TP w/IT	264.5	7.0	257.5	7.0	257.5		N/E 3
TP-10	TP w/IT	263.6	9.5	254.1	9.5	254.1	9.5	254.1

1. TP w/IT = Test Pit with Infiltration Testing
2. B w/MW = Boring with Monitoring Well
3. N/E = Not encountered
4. N/A = Not Applicable for Borings with Monitoring Wells

Drawn By: & Date/Time: hoesse, Jan 10, 2020 - 12:40pm
 Drawing Location & Name: S:\Projects\ENV\60537383_NESE_CS206\900-CAD-910-CAD\20-PCSM-SHEETS\12-13 - Basin_Profile_Plan_CS_206.dwg



KEVIN MCKEON, P.E.
NEW JERSEY
PROFESSIONAL ENGINEER NO GE32586

REVISIONS						
NO.	DATE	BY	DESCRIPTION	W.O. NO.	CHK.	APP.
0	06/15/17	GMS	SUBMITTED TO SOMERSET-UNION SCD	1185732	PPH	KDM
1	08/11/17	GMS	REVISED NJDEP AND SCD SUBMISSION	1185732	PPH	KDM
2	01/05/18	GMS	REVISED WORKSPACE	1185732	PPH	KDM
3	02/09/18	GMS	REVISED SUBMISSION TO SOMERSET-UNION SCD	1185732	PPH	KDM
4	06/05/18	PPH	SUBMITTED TO NJDEP	1185732	TFP	KDM
5	08/24/18	GMS	SUBMITTED TO NJDEP	1185732	PPH	KDM
6	02/01/19	PPH	SUBMITTED TO NJDEP	1185732	TFP	KDM
7	04/22/19	PPH	SUPPLEMENTAL INFORMATION	1185732	PPH	KDM
8	05/03/19	PPH	REVISED BASIN GRADING	1185732	PPH	KDM
9	06/07/19	PPH	REVISED BASIN GRADING	1185732	GMS	KDM
10	06/24/19	PPH	LOD REDUCTION IN WETLAND TRANSITION	1185732	GMS	KDM
11	01/15/20	PPH	NJDEP SUBMISSION	1185732	TFP	KDM

TRANSCONTINENTAL GAS PIPE LINE COMPANY, LLC.
 POST CONSTRUCTION STORMWATER MANAGEMENT PLAN
 NORTHEAST SUPPLY ENHANCEMENT PROJECT
 COMPRESSOR STATION NO. 206 - TRAP ROCK ACCESS ROAD
 INFILTRATION BASIN PROFILE PLAN
 FRANKLIN TOWNSHIP, SOMERSET COUNTY, NJ


Williams
GAS PIPELINE

DRAWN BY: GMS	DATE: 06/15/17	ISSUED FOR BID: TBD	SCALE: AS NOTED
CHECKED BY: PPH	DATE: 06/15/17	ISSUED FOR CONSTRUCTION: TBD	REVISION: 11
APPROVED BY: KDM	DATE: 06/15/17	DRAWING NUMBER:	SHEET 12 OF 13
WO: 1185732			

LEGEND

- EXISTING FEATURES**
- 265 — EXISTING MAJOR CONTOUR
 - - - - - EXISTING MINOR CONTOUR
 - — — — — STREAM CENTERLINE
 - WETLAND
 - — — — — EXISTING TREE LINE
 - — — — — PARCEL LINE
 - — — — — EXISTING ACCESS ROADS
 - — — — — EXISTING FENCE
 - OHE — EXISTING OVERHEAD POWER LINE
 - — — — — EXISTING PIPELINE
 - — — — — EXISTING RIGHT OF WAY


- PROPOSED FEATURES**
- LOD — LIMIT OF DISTURBANCE
 - — — — — PROPOSED CONTOUR MAJOR
 - - - - - PROPOSED CONTOUR MINOR
 - GAS — PROPOSED PIPELINE
 - - - - - CULVERT
 - RIP RAP APRON
 - X — PROPOSED FENCE
 - — — — — PROPOSED TREE LINE
 - — — — — PROPOSED GRAVEL
 - — — — — PROPOSED CONCRETE
 - — — — — RIPRAP SLOPE PROTECTION
 - — — — — PROPOSED BRUSH SEED MIX
 - TP-8 ● SOIL TEST LOCATION

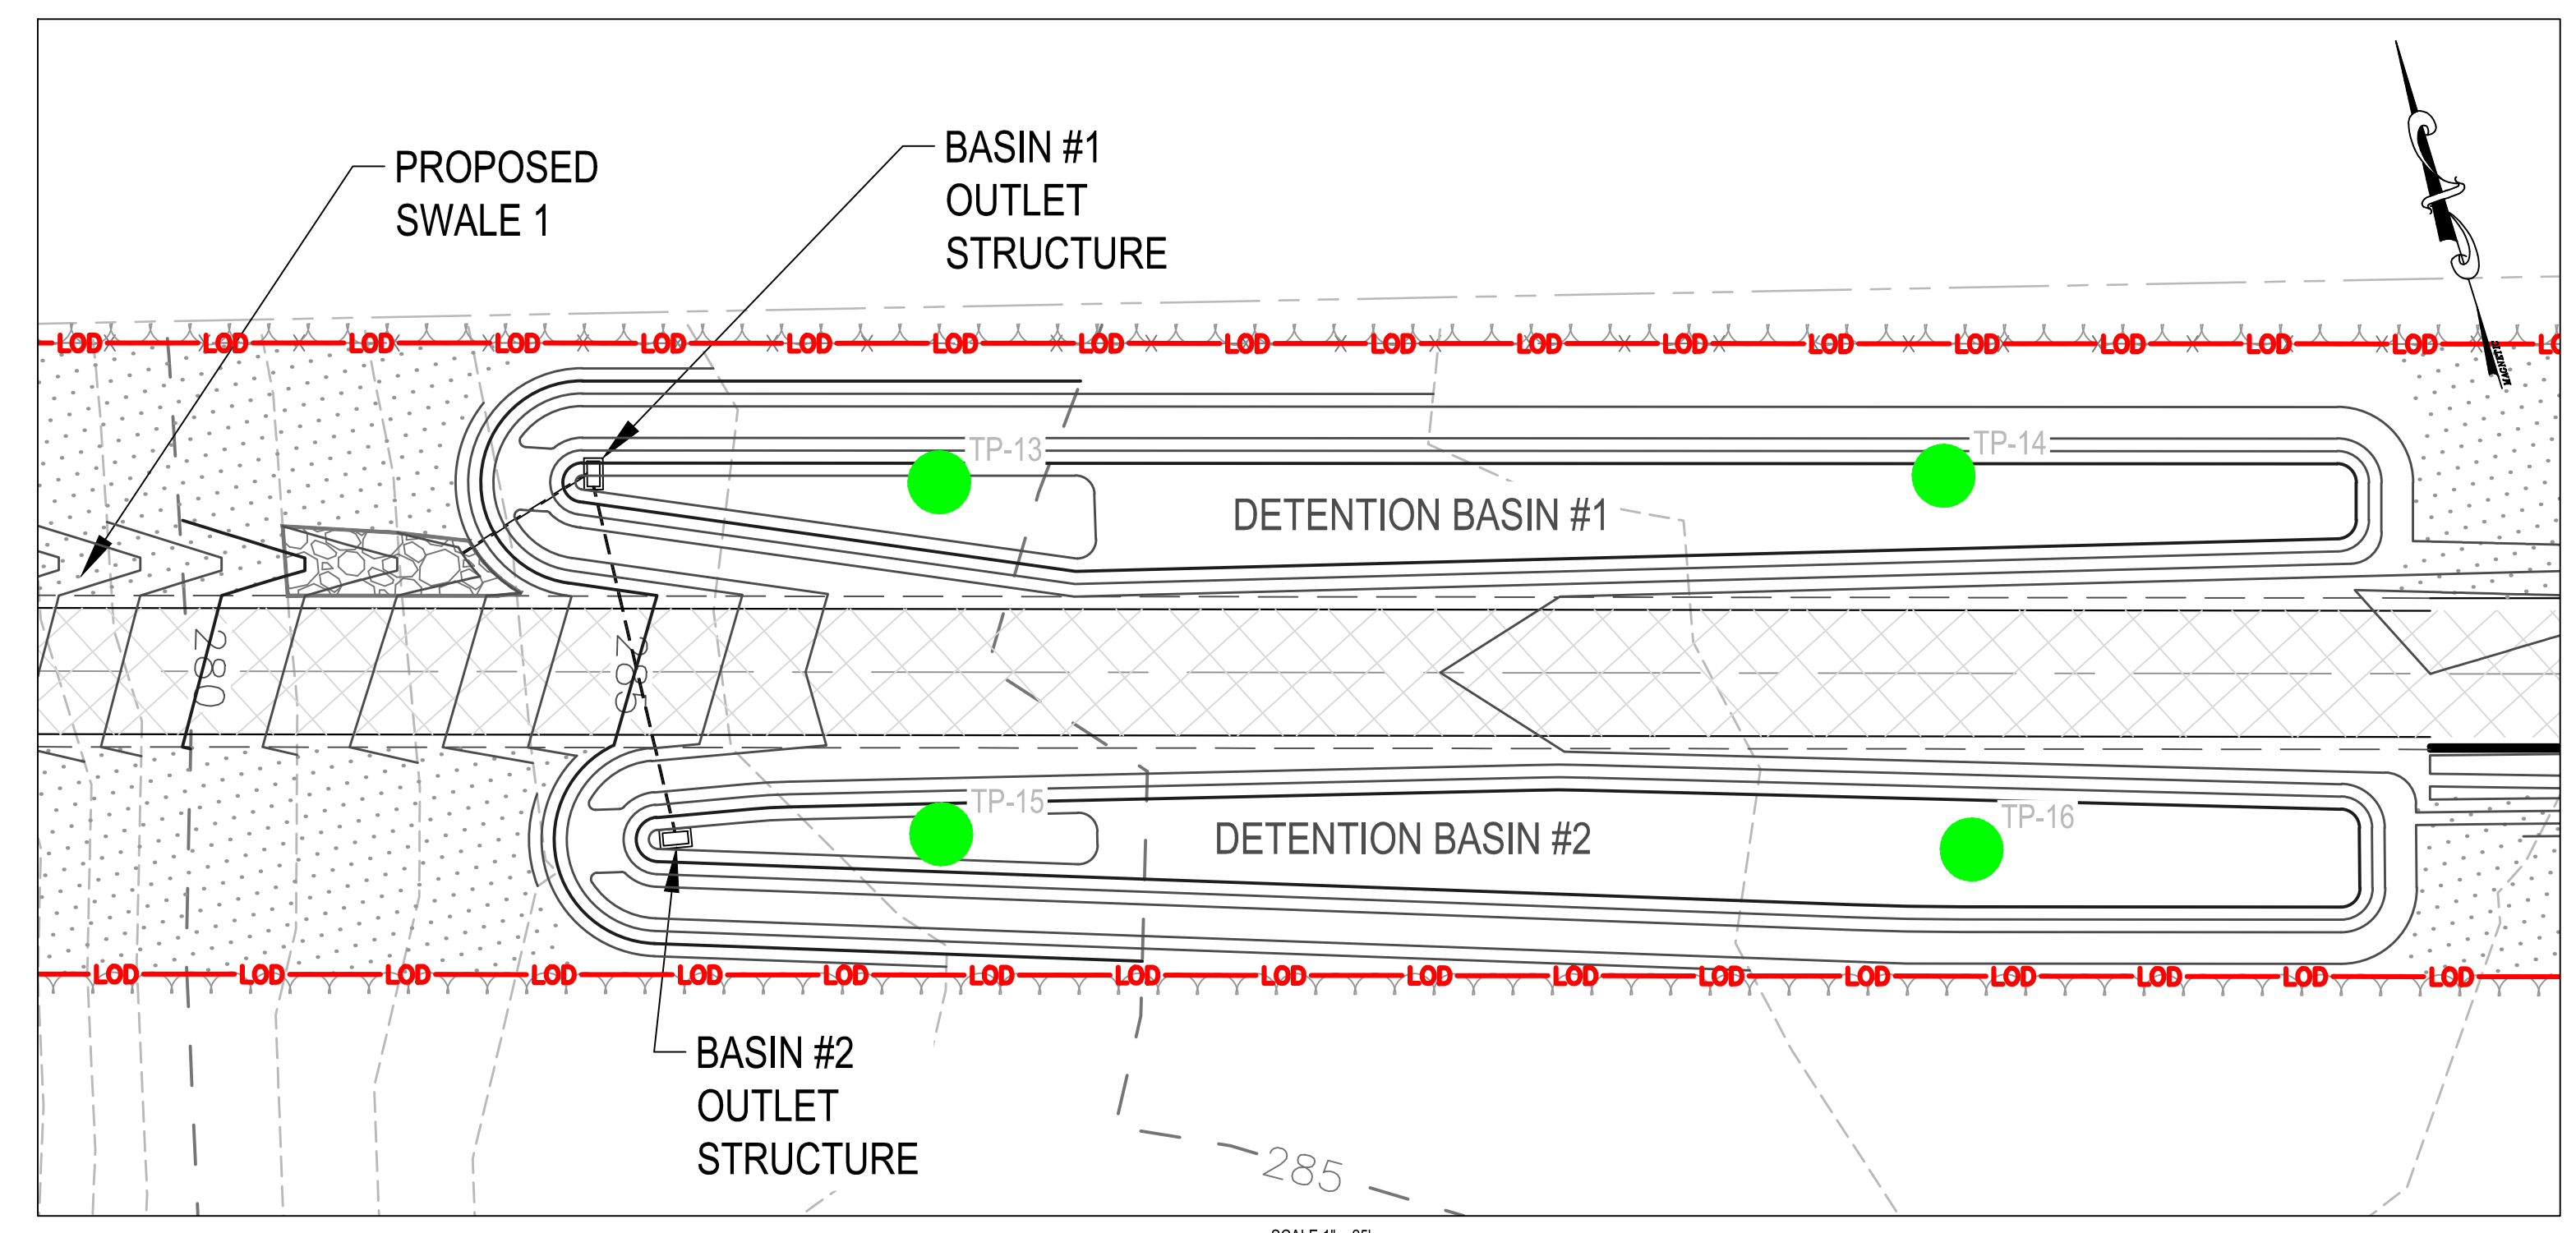


SCALE 1" = 25'

Location I.D.	Test Type ¹	Existing Grade (ft)	Test Pit Bottom		Bedrock		Groundwater	
			Depth (ft)	Elevation (ft)	Depth (ft)	Elevation (ft)	Depth (ft)	Elevation (ft)
			TP-13	TP	284.8	4.0	280.8	N/E ²
TP-14	TP	286.5	4.2	282.3	N/E ²		4.1	282.4
TP-15	TP	284.4	4.0	280.4	N/E ²		3.9	280.4
TP-16	TP	286.4	4.0	282.4	N/E ²		3.8	282.6

1. TP = Test Pit
2. N/E = Not encountered

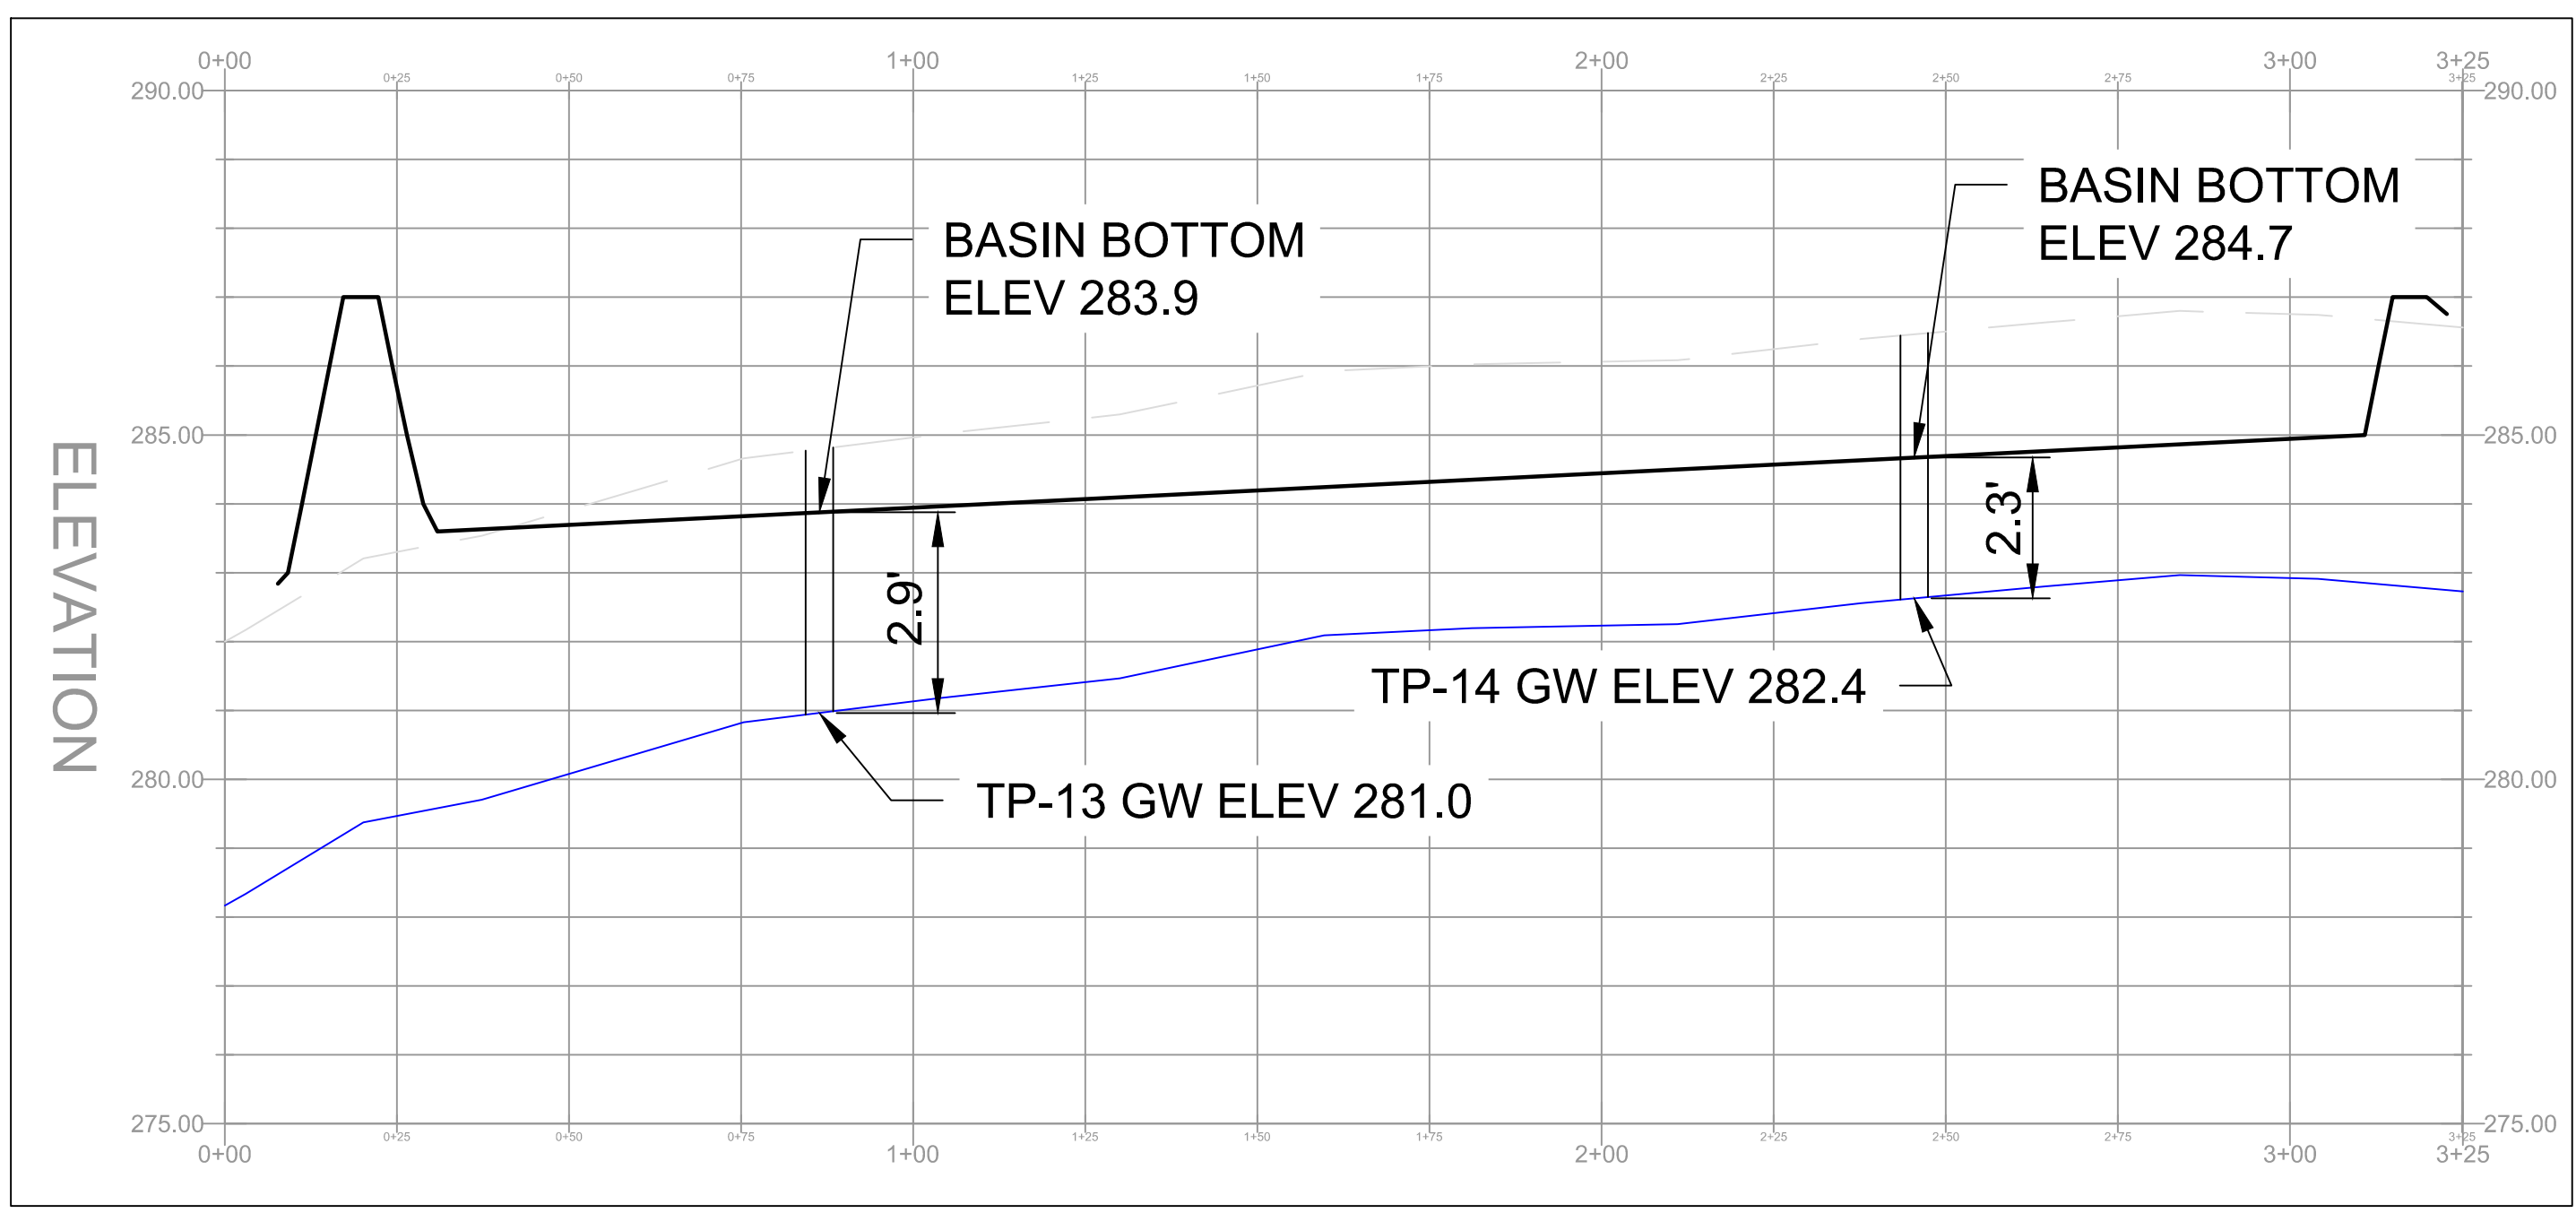

DETENTION BASIN #1 PROFILE

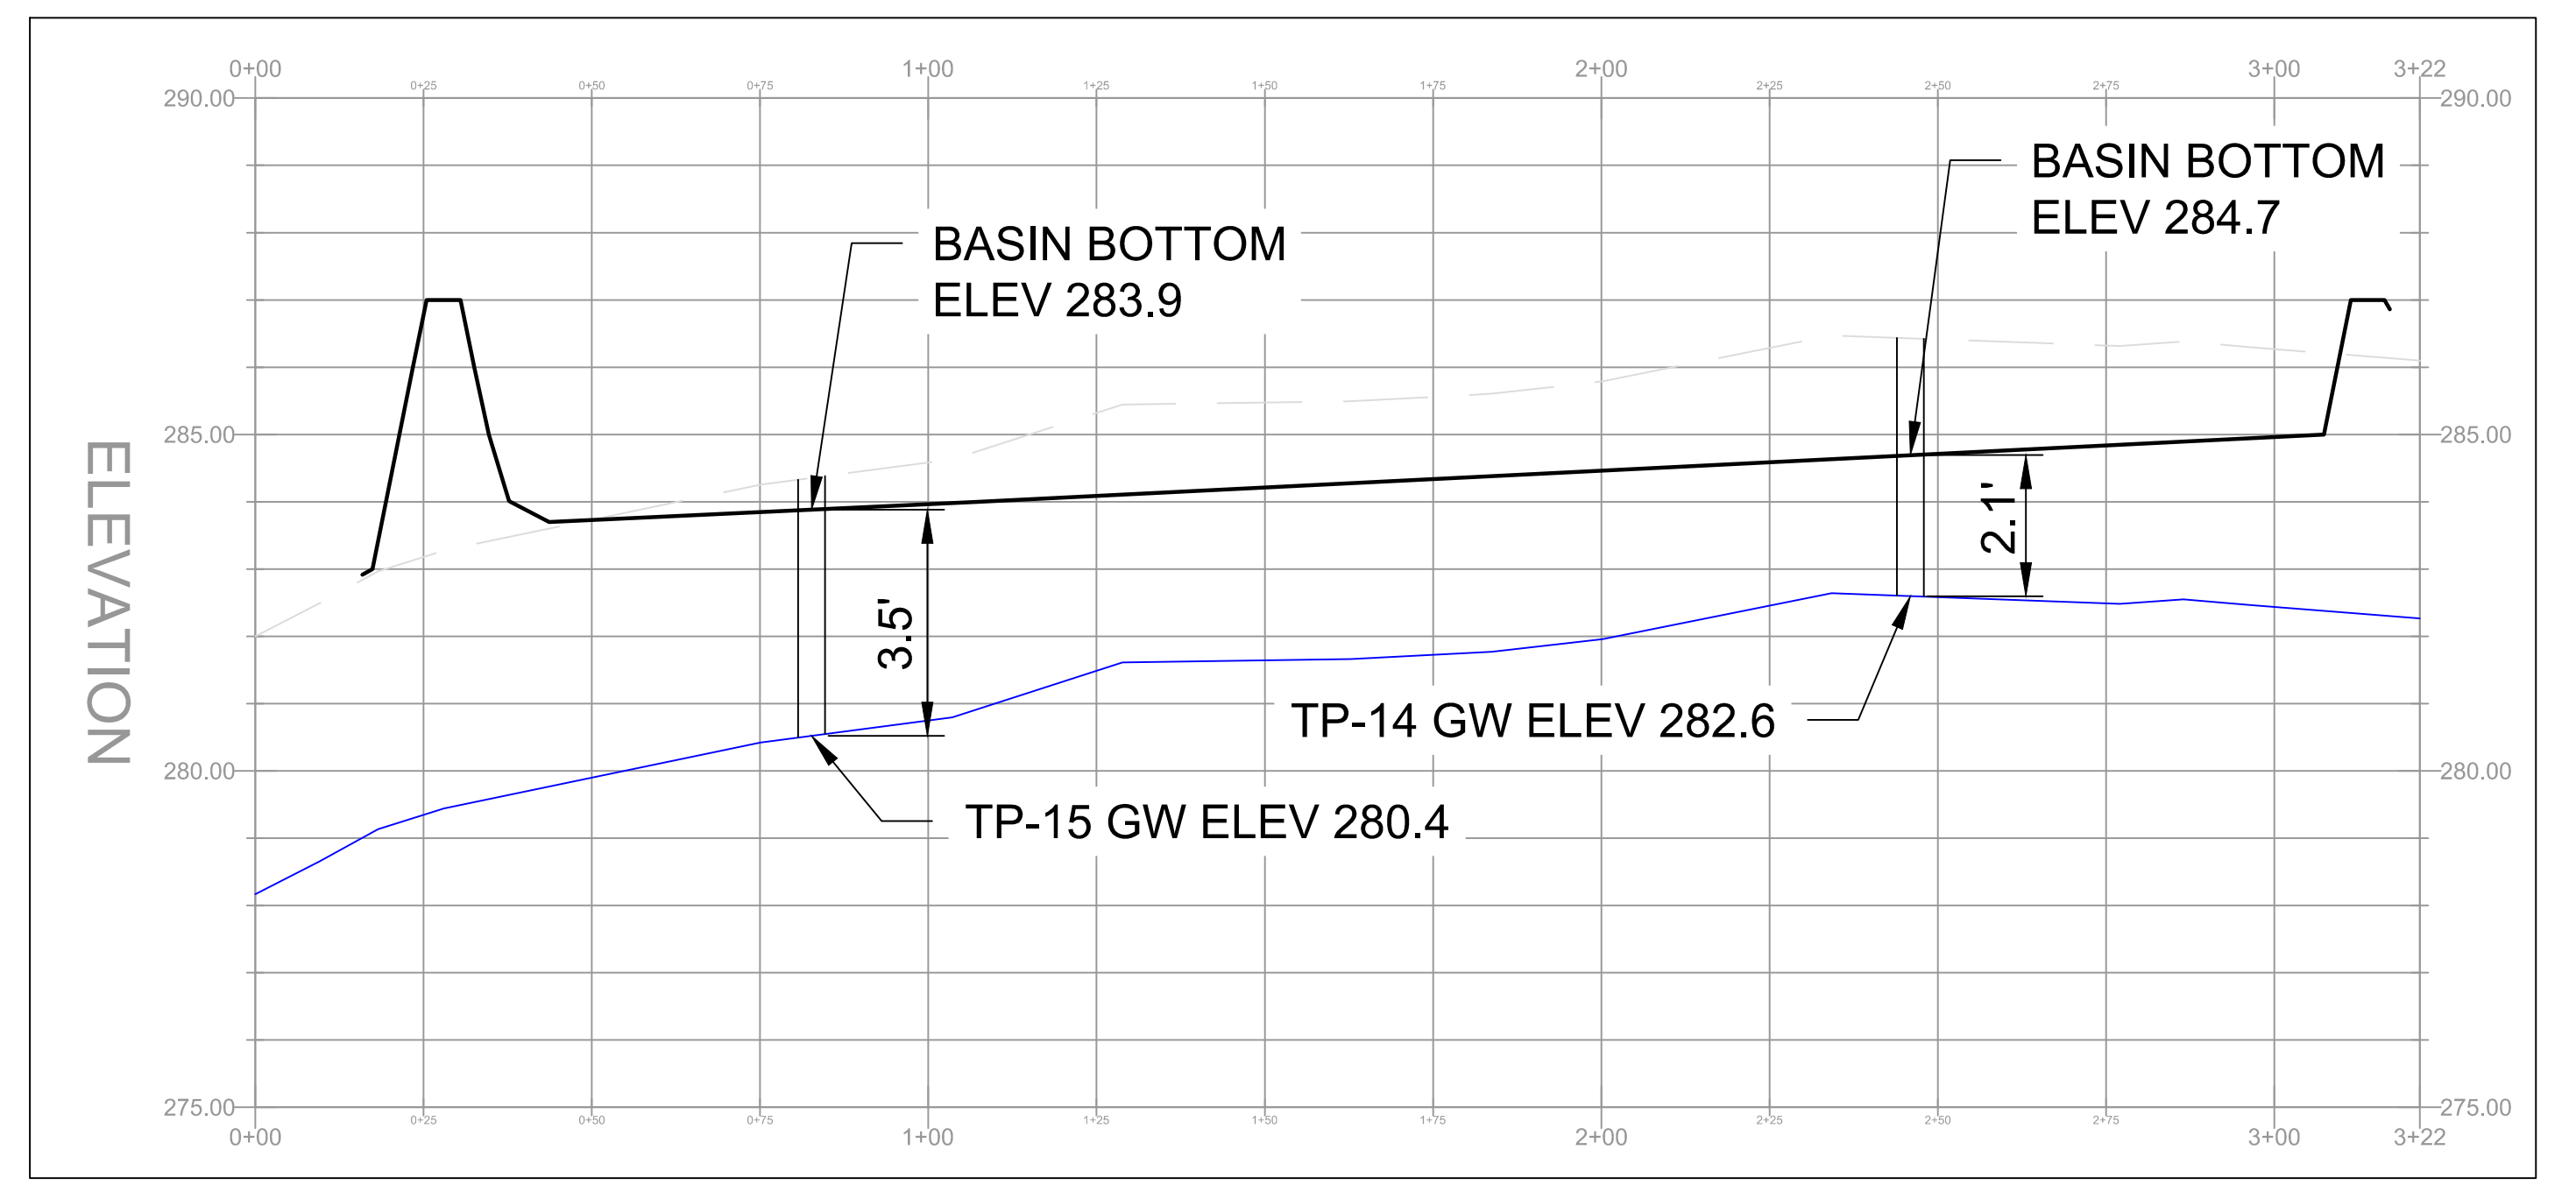

DETENTION BASIN #2 PROFILE

Drawn By: & Date/Time: harsse Jan 10, 2020 12:40pm
Drawing Location & Name: S:\Projects\ENV\60537383_NESE_CS206\900-CAD-GIS\910-CAD\20-PCSM SHEETS\12-13 - Basin Profile Plan CS 206.dwg



625 WEST RIDGE PIKE, SUITE E-100
CONSHOHOCKEN, PA 19428
(610) 832-3500

KEVIN MAREON, P.E.
NEW JERSEY
PROFESSIONAL ENGINEER NO GE32586

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APPROVED BY: KDM	DATE: 06/15/17	DRAWING NUMBER:	SHEET 13 OF 13