
NJDEP LAND USE PERMIT PLANS

FOR THE

NORTHEAST SUPPLY ENHANCEMENT PROJECT PROPOSED 26" RARITAN BAY LOOP (OFFSHORE)

TRANSCONTINENTAL GAS PIPE LINE COMPANY LLC



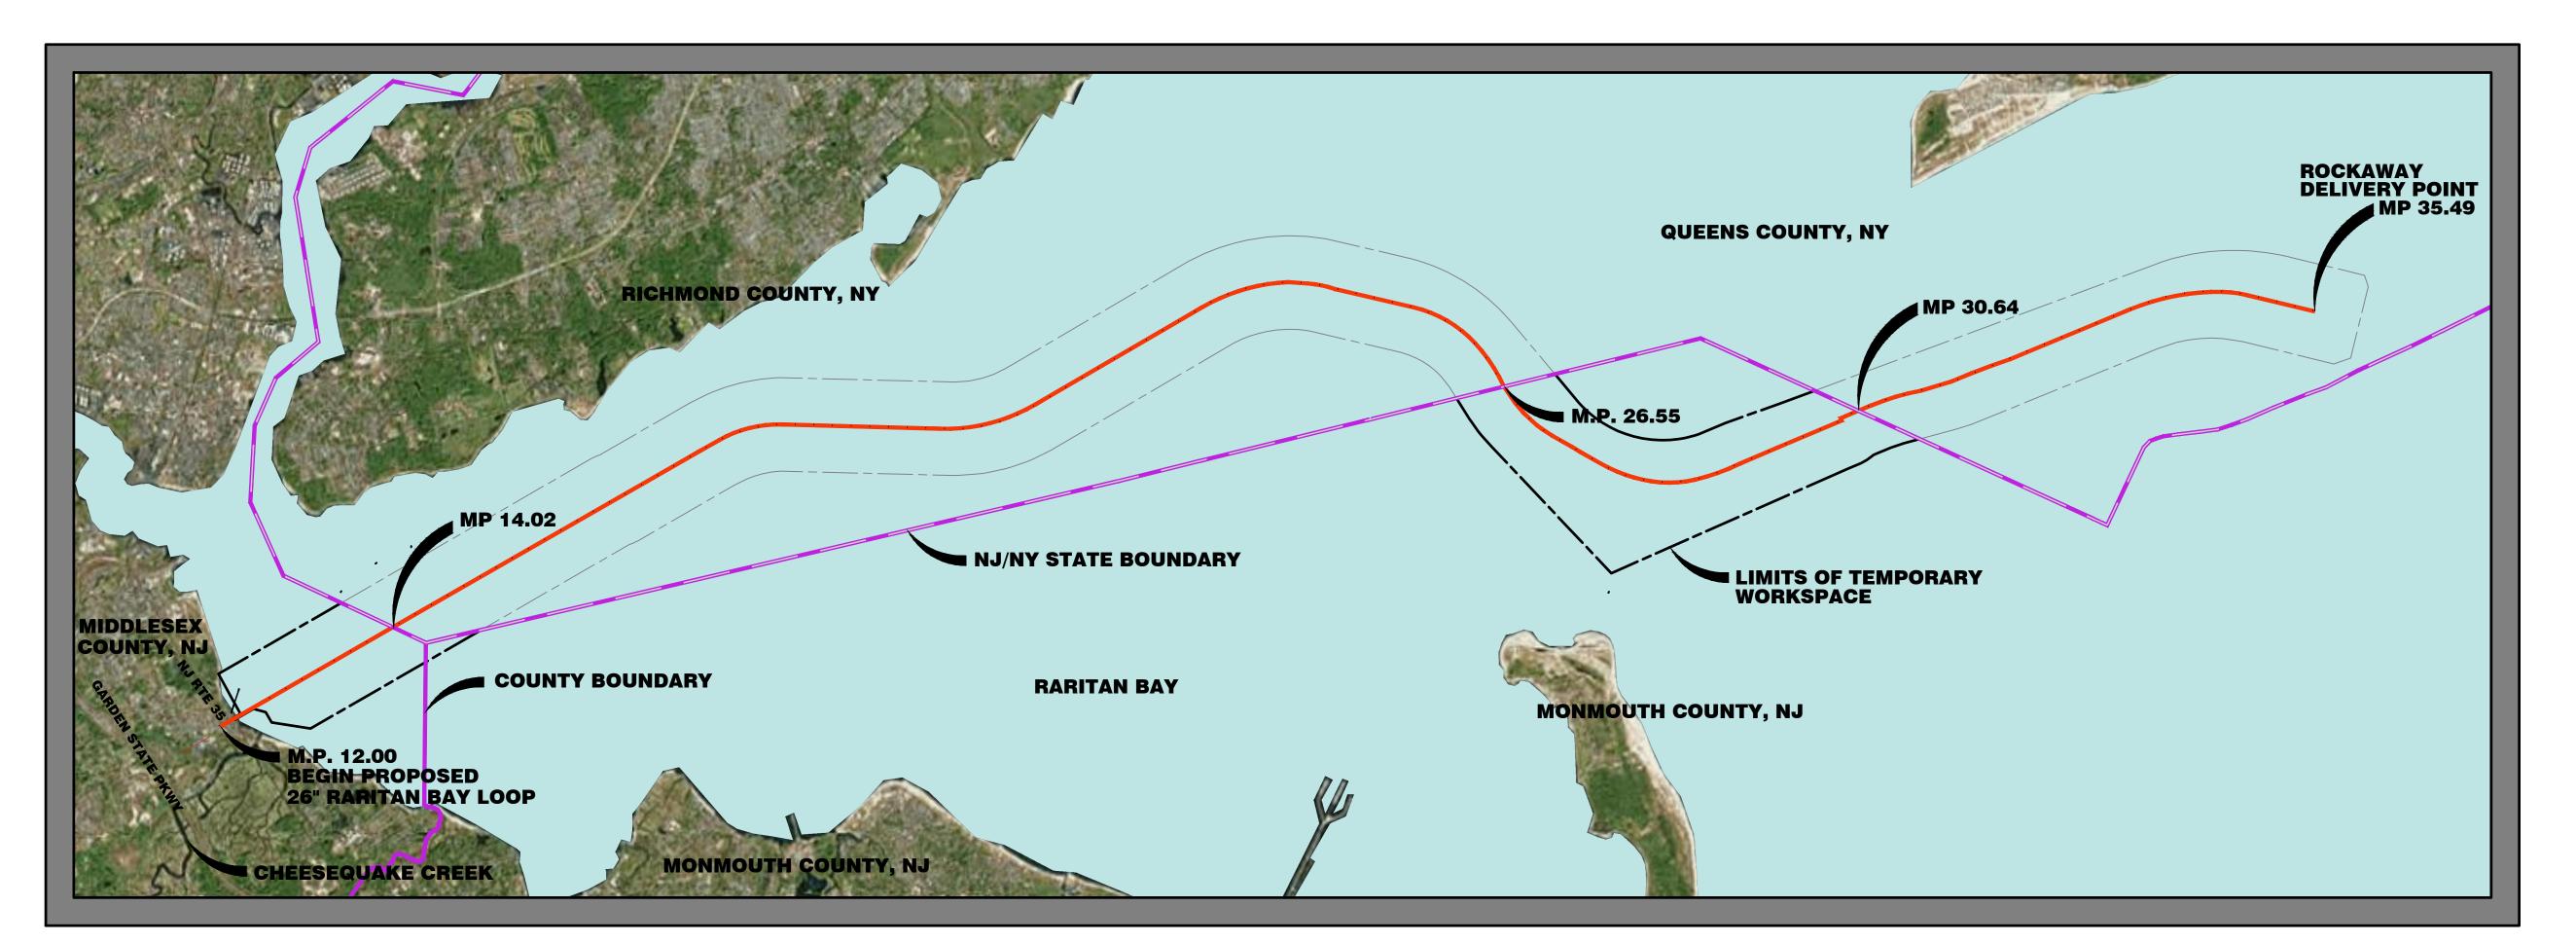


AERIAL KEY MAP

SOURCE: ARCGIS WORLD IMAGERY MAP SERVICE WWW.MAPS.US.NEARMAP.COM, AERIAL MAPS, MARCH 30, 2017 SCALE: 1" = 5000"

DRAWING LIST			
DWG. NO.	DWG. TITLE	ISSUED	LAST REVISED
1	COVER SHEET	06/08/18	10/11/19
2	GENERAL NOTES	06/08/18	10/11/19
3	WATERFRONT DEVELOPMENT PERMIT PLAN (MILE 12.00 TO 14.02)	06/08/18	10/11/19
4	WATERFRONT DEVELOPMENT PERMIT PLAN (MILE 26.55 TO 28.90)	06/08/18	10/11/19
5	WATERFRONT DEVELOPMENT PERMIT PLAN (MILE 28.90 TO 30.64)	06/08/18	10/11/19
6	CONSTRUCTION DETAILS	06/08/18	10/11/19
7	CONSTRUCTION DETAILS	06/08/18	10/11/19
8	CONSTRUCTION DETAILS	06/08/18	10/11/19

SUPPLEMENTAL DRAWING LIST				
DWG. NO.	DWG. TITLE	ISSUED	LAST REVISED	
1	PERMIT PLAN - RARITAN BAY LOOP OFFSHORE STAGING AREA	06/08/18	_	

REV./ ISSUE	DATE	DESCRIPTION
1	10/11/19	REV NOTES ON PLANS

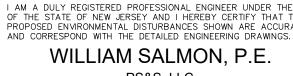

1433 HIGHWAY 34, SUITE A-4, WALL, NJ 07727 PROFESSIONAL ENGINEER N.J. LIC. NO. 41319 COA NO. 24GA28032700





CERTIFICATE OF AUTHORIZATION NO. 24GA28032700

OPYRIGHT 2017 PAULUS, SOKOLOWSKI AND SARTOR, LLC. — ALL RIGHTS RESERVED.

NORTHEAST SUPPLY **ENHANCEMENT PROJECT PROPOSED**

26" RARITAN BAY LOOP

MIDDLESEX & MONMOUTH COUNTY, NEW JERSEY

SHEET TITLE

COVER SHEET

DRAWN BY: JPS

CHECKED BY: WS

AS NOTED 06/08/18 SHEET 1 OF 8

SHEET NO.

WATERFRONT DEVELOPMENT PLANS

STATE PLANE COORDINATES				
PROPOSED GAS				
PIPELINE	EASTING	NORTHING		
CENTERLINE	EASTING	NORTHING		
STATIONING				
279+62	557499	594178		
280+00	557532	594197		
290+00	558398	594697		
300+00	559265	595197		
310+00	560131	595697		
320+00	560997	596197		
330+00	561863	596697		
340+00	562729	597197		
350+00	563595	597696		
360+00	564461	598196		
370+00	565327	598696		
380+00	566193	599196		
386+05	566717	599499		
1048+08	626219	612376		
1050+00	626320	612213		
1060+00	626889	611391		
1070+00	627567	910657		
1080+00	628343	610028		
1090+00	629196	609506		
1100+00	630063	609009		
1110+00	630931	608511		
1120+00	631802	608020		
1130+00	632721	607628		
1140+00	633686	607371		
1150+00	634678	607254		
1160+00	635677	607279		
1170+00	636662	607447		
1180+00	637613	607752		
1190+00	638536	608139		
1200+00	639458	608525		
1210+00	639901	608711		
1220+00	640380	608912		
1230+00	641302	609299		
1240+00	642225	609686		
1250+00	643147	610072		
1260+00	644069	610459		
1263+97	645169	611083		

NOTES ON USE OF PLANS:

ANGLES CONTAINED ON THE DRAWINGS.

- 1. UNLESS THESE PERMIT DRAWINGS ARE SPECIFICALLY DESIGNATED AS "CONSTRUCTION ISSUE," THESE DRAWINGS SHALL NOT BE USED FOR PERMITTING ASSOCIATED WITH CONSTRUCTION OR THE IMPROVEMENTS DEPICTED HEREIN. CONTRACTORS SHALL NOTIFY THE DESIGN ENGINEER TO OBTAIN PERMITTING DOCUMENTS. THESE PLANS ARE FOR NJDEP PERMITTING ONLY, NO CONSTRUCTION IS TO BE BASED UPON THESE PLANS.
- 2. ALL DIMENSIONS MUST BE VERIFIED IN THE FIELD DURING CONSTRUCTION BY THE CONTRACTOR. NOTIFY PAULUS, SOKOLOWSKI AND SARTOR, LLC OF ANY CONFLICTS, ERRORS, AMBIGUITIES OR DISCREPANCIES IN THE CONTRACT DRAWINGS OR SPECIFICATIONS BEFORE PROCEEDING WITH CONSTRUCTION.
- 3. ALL DIMENSIONS SHALL BE AS NOTED IN WORDS OR NUMBERS ON THE CONTRACT DRAWINGS. DO NOT SCALE THE DRAWINGS TO DETERMINE DIMENSIONS.
- 4. THESE CONTRACT DRAWINGS CONTAIN DATA INTENDED SPECIFICALLY FOR THE NOTED PROJECT AND CLIENT. THEY ARE NOT INTENDED FOR USE ON EXTENSIONS OF THIS PROJECT OR FOR REUSE ON ANY OTHER PROJECT.
- 5. THE COPYING AND/OR MODIFICATION OF THIS DOCUMENT OR ANY OTHER PORTION THEREOF WITHOUT THE WRITTEN PERMISSION OF PAULUS, SOKOLOWSKI, AND SARTOR, LLC IS EXPRESSLY PROHIBITED.
- 6. INFORMATION FOR DESIGN LAYOUT IS CONTAINED SOLELY IN THE WRITTEN DIMENSIONS, BEARINGS, AND
- 7. THIS DIMENSIONAL INFORMATION IS NOT WARRANTED NOR SHOULD IT BE CONSIDERED AS COMPLETE FOR EVERY ASPECT OF THE LAYOUT. STANDARD PRACTICE REQUIRES THAT THE LAYOUT PERSON CHECK THE DIMENSIONAL DATA CONSISTENCY AND TO PERFORM SURVEY CALCULATIONS WHICH ARE CUSTOMARY FOR CONSTRUCTION LAYOUT. IN THE EVENT THAT A QUESTION OR INCONSISTENCY IS DISCOVERED, THE INSTALLER SHALL IMMEDIATELY NOTIFY THE DESIGN ENGINEER, PAULUS, SOKOLOWSKI, AND SARTOR, LLC.
- 8. THE GRAPHICAL INFORMATION CONTAINED IN ELECTRONIC FILES IS INTENDED AS DRAWING DATA ONLY. IT IS NOT INTENDED TO SERVE AS SURVEY LAYOUT DATA.
- 9. ALL PROPOSED FITTING ANGLES ARE APPROXIMATE. CONTRACTOR TO FIELD VERIFY PRIOR TO CUTTING.

GENERAL NOTES:

- 1. LOCATION OF EXISTING UTILITIES WITHIN THE LIMIT OF DISTURBANCE / TEMPORARY WORKSPACE OF PROJECT MUST BE FIELD VERIFIED BEFORE WORK MAY COMMENCE. ANY CONFLICTING INFORMATION FROM THAT SHOWN SHALL BE BROUGHT TO THE IMMEDIATE ATTENTION OF THE DESIGN ENGINEER, PAULUS, SOKOLOWSKI, AND SARTOR, LLC.
- 2. UNLESS SPECIFICALLY SHOWN HEREIN, THE DESIGN ENGINEER, PAULUS, SOKOLOWSKI, AND SARTOR, LLC HAS NOT CONDUCTED AN INVESTIGATION OR PROVIDED DATA ON THE NATURE OF, OR STRUCTURAL SUITABILITY OF ANY SUBSURFACE MATERIALS. THE CONTRACTOR SHALL NOTIFY THE DESIGN ENGINEER, PAULUS, SOKOLOWSKI, AND SARTOR, LLC IN WRITING OF ANY UNUSUAL SOIL OR ROCK CONDITIONS ENCOUNTERED.
- 3. THE CONTRACTOR SHALL BE RESPONSIBLE FOR INSTALLING WARNING SIGNS, BARRICADES, AND ANY AND ALL SAFETY MEASURES AS MAY BE REQUIRED BY LOCAL CODE, OSHA, STANDARD PRACTICE, AND/OR COMMON SENSE AND MAINTENANCE THEREOF. LETTERING SHALL BE A MINIMUM OF 2" HIGH AND SHALL BE OF A COLOR THAT CONTRASTS WITH THE SIGN.
- 4. ALL ONSHORE SOIL EROSION AND SEDIMENT CONTROL STRUCTURES AND MEASURES SHALL BE IN PLACE PRIOR TO ANY SITE DISTURBANCE.
- 5. CONTRACTOR TO RESTORE GROUND SURFACE OF GAS PIPELINE TRENCH, CONSTRUCTION STAGING AREAS, AND ALL OTHER DISTURBED AREAS TO THEIR ORIGINAL CONDITION OR BETTER, OR AS SPECIFIED IN THESE PLANS.
- 6. THE CONTRACTOR SHALL PREPARE AS—BUILT DRAWINGS FOR ALL UNDERGROUND IMPROVEMENTS INSTALLED DURING CONSTRUCTION, ETC. AS—BUILT DRAWINGS MUST BE SIGNED AND SEALED BY A NJ PROFESSIONAL ENGINEER OR LAND SURVEYOR. THE AS—BUILT SURVEY DRAWINGS MUST COMPLY WITH UTILITY OWNER STANDARDS / REQUIREMENTS. COPIES SHALL BE SUBMITTED TO UTILITY COMPANY AND/OR OWNER.
- 7. TRENCHING AND DREDGING WILL BE COMPLETED BY CLAMSHELL DREDGE, JET TRENCHER OR HAND JETS ACCORDING TO BURIAL DEPTH REQUIREMENTS, THE NATURE OF AREAS TO BE EXCAVATED AND WATER DEPTHS. BACKFILLING WILL BE COMPLETED USING CLAMSHELL AND PIPELAYING WILL BE COMPLETED USING PIPELAY BARGE. REFER TO SITE PLANS PROVIDED BY TRANSCONTINENTAL GAS PIPE LINE COMPANY, LLC.
- 8. TRANSCO PLANS TO INSTALL A TEMPORARY FIXED PLATFORM AT MP 12.50 TO SUPPORT OPERATIONS ASSOCIATED WITH THE MORGAN SHORE HDD AND SHALLOW WATER PIPELAY OPERATIONS. DUE TO THE SHALLOW WATERS FROM MP 12.50 TO MP 16.50 AND DRAFT RESTRICTIONS OF THE PIPELAY BARGE TO BE USED FOR CONSTRUCTION, THE PIPELAY BARGE WILL BE MOORED AT MP 14.50 WHERE THE BARGE WILL FABRICATE TWO PIPE STRINGS THAT WILL BE PULLED ON BOTTOM IN A PRE-DREDGED TRENCH TOWARDS MP 12.50 VIA A WINCH LOCATED ON THE FIXED PLATFORM. THE PIPELAY BARGE WILL THEN RELOCATE AND MOOR AT MP 16.50, WHERE ANOTHER PIPE STRING WILL BE FLOATED FROM MP 16.50 TO MP 14.50 UNDER CONTROL OF THE FIXED PLATFORM WINCH. ONCE IN POSITION, THIS PIPE STRING WILL BE SUNK INTO THE PRE-DREDGED TRENCH. TRANSCO WILL INSTALL GUIDE PILES FROM MP 14.50 TO MP 16.50 TO ASSIST THE PIPE PULL OPERATIONS AND WILL ATTACH BUOYANCY MODULES TO THE STRINGS DURING THE PULL—IN PROCESS. ONCE THE INDIVIDUAL PIPE STRINGS ARE IN PLACE, THE BUOYANCY MODULES WILL BE REMOVED, AND THE STRINGS WILL BE FLOODED.

COASTAL ZONE MANAGEMENT NOTES:

- 1. THE PURPOSE OF THESE PLANS IS TO SECURE NEW JERSEY DEPARTMENT OF ENVIRONMENTAL PROTECTION COASTAL ZONE MANAGEMENT PERMITS FOR THE PROPOSED CONSTRUCTION OF A 26-INCH GAS TRANSMISSION MAIN OFFSHORE WITHIN RARITAN BAY. SEE NORTHEAST SUPPLY ENHANCEMENT PROJECT PROPOSED 26" MADISON LOOP WATERFRONT DEVELOPMENT PERMIT PLANS FOR CONTINUATION OF ONSHORE IMPROVEMENTS.
- A. COASTAL ZONE MANAGEMENT PERMIT, WATERFRONT DEVELOPMENT INDIVIDUAL PERMIT WATERFRONT DEVELOPMENT INDIVIDUAL PERMIT WATER, COASTAL / TIDAL PERMIT; N.J.A.C. 7:7
- 2. THE APPLICANT/OWNER SHALL SECURE ALL PROPOSED PERMANENT AND TEMPORARY EASEMENTS AND RIGHTS OF ACCESS SHOWN ON THE PLANS PRIOR TO CONSTRUCTION. THE OWNER/CONTRACTOR SHALL ALSO SECURE NECESSARY EASEMENTS OR RIGHTS OF ACCESS BEYOND THE LIMITS SHOWN, AS DEEMED NECESSARY.
- 3. REFER TO PLANS ENTITLED "TRENCH CROSS—SECTION FOR PRE AND POST PIPELAY TRENCHING", REVISED NOVEMBER 20, 2017, PREPARED BY INTECSEA WORLEY PARSONS GROUP, PROVIDED BY TRANSCONTINENTAL PIPE LINE COMPANY, LLC. FOR MINIMUM COVER OF THE TRANSMISSION GAS MAIN ACCORDING TO EXCAVATION METHOD, NATURE OF THE AREAS TO BE EXCAVATED AND WATER DEPTHS.
- 4. TRENCHING AND DREDGING WILL BE COMPLETED BY CLAMSHELL DREDGE, JET TRENCHER OR HAND JETS ACCORDING TO BURIAL DEPTH REQUIREMENTS, THE NATURE OF AREAS TO BE EXCAVATED AND WATER DEPTHS. BACKFILLING WILL BE COMPLETED USING CLAMSHELL AND PIPELAYING WILL BE COMPLETED USING PIPELAY BARGE. REFER TO SITE PLANS ENTITLED "TRENCH CROSS—SECTION FOR PRE AND POST PIPELAY TRENCHING", LAST REVISED NOVEMBER 20, 2017, PREPARED BY INTECSEA, PROVIDED BY TRANSCONTINENTAL GAS PIPE LINE COMPANY, LLC.
- 5. TEMPORARY WORKSPACE WITHIN THE WATERFRONT DEVELOPMENT ZONE BELOW MEAN HIGH WATER ELEVATION IS 3,703 ACRES.
- 6. OPERATIONAL EASEMENT IS 30 FEET CENTERED ON PIPELINE ROUTE AND EQUIVALENT TO 22.40 ACRES (975,744 SF) IN NEW JERSEY. THIS ACREAGE REFLECTS THE OPERATIONAL EASEMENT THAT WILL BE ACQUIRED FOR THE RARITAN BAY LOOP; HOWEVER, FOLLOWING INSTALLATION NO ROUTINE BOTTOM DISTURBING IMPACTS ASSOCIATED WITH OPERATIONS ARE ANTICIPATED. FURTHER MAINTENANCE IS EXPECTED TO BE MINIMAL BASED ON THE OPERATIONAL LIFE OF THE PIPELINE.

REFERENCE NOTES

- 1. ONSHORE EXISTING CONDITIONS SHOWN HEREON ARE BASED UPON SURVEY INFORMATION PREPARED BY D.W. SMITH ASSOCIATES, LLC AND WILLIAMS TRANSCONTINENTAL GAS PIPE LINE COMPANY, LLC.
- 2. THE HORIZONTAL DATUM REFERS TO NAD83 NEW JERSEY STATE PLANE COORDINATE SYSTEM.
- 3. BATHYMETRY BASED UPON PLANS ENTITLED "GEOPHYSICAL SURVEY AND DATA ASSESSMENT FOR THE NORTHEAST SUPPLY ENHANCEMENT PROJECT, OFFSHORE RARITAN BAY LOOP", DATED 2016, PREPARED BY ROGERS SURVEYING, PLLC, PROVIDED BY TRANSCONTINENTAL GAS PIPE LINE COMPANY, LLC. IN MEAN LOWER LOW WATER DATUM (CONVERSION TO NGVD 1929; -1.87 FT.) THE VERTICAL DATUM FOR ONSHORE REFERS TO NAVD 88 TOPOGRAPHICAL DATA. (CONVERSION TO NGVD 1929; +1.04 FT.)
- 4. PORTION OF RARITAN BAY LOOP ABOVE MEAN HIGH WATER LINE IS SHOWN ON NORTHEAST SUPPLY ENHANCEMENT PROJECT 26" MADISON BAY LOOP WATERFRONT DEVELOPMENT PERMIT PLANS, DATED JUNE 8, 2018, PREPARED BY PAULUS, SOKOLOWSKI AND SARTOR, LLC.
- 5. THESE PERMIT PLANS ARE BASED UPON GAS ALIGNMENT PLANS ENTITLED "TRANSCONTINENTAL GAS PIPE LINE COMPANY, LLC FERC ALIGNMENT SHEET NORTHEAST SUPPLY ENHANCEMENT PROJECT PROPOSED 26" RARITAN BAY LOOP M.P. 12.00 TO M.P. 35.49 OFFSHORE", LAST REVISED MAY 9, 2018, PREPARED BY INTECSEA WORLEY PARSONS GROUP, AS PROVIDED BY TRANSCONTINENTAL GAS PIPE LINE COMPANY, LLC IN GIS FORMAT (SHAPEFILES).
- 6. THE FOLLOWING ADDITIONAL INFORMATION WAS PROVIDED BY WILLIAMS TRANSCONTINENTAL GAS PIPE LINE COMPANY, LLC AND/OR ECOLOGY AND ENVIRONMENT, INC. IN GIS FORMAT (SHAPEFILES) FROM VARIOUS SOURCES:
 - A. NOAA SHIPPING LANES
 - . COMMERCIAL WHALE WATCHING GENERAL USE AREA
 . NATIONAL PARKS SERVICE AREAS
 - D. OFFSHORE HARBOR CAUTION AREAS
 E. NEW JERSEY SHELLFISH GROWING WATERS LIMITS
 - F. NEW JERSEY HARD CLAM HABITAT
 G. LIMITS OF SURFCLAM PRELIMINARY DISTRIBUTION AREA
 - H. NJDEP SPORT FISHING AREASI. CHEESEQUAKE STATE PARK LIMITS
- 7. NEW YORK STATE BOUNDARY LINES TAKEN FROM "NYS GIS PROGRAM OFFICE COUNTY BOUNDARIES", 2013. NEW JERSEY COUNTY LINES TAKEN FROM "COUNTIES OF NEW JERSEY, NJ OFFICE OF INFORMATION TECHNOLOGY, OFFICE OF GEOGRAPHIC INFORMATION SYSTEMS", 2015.
- 8. MEAN HIGH WATER LEVEL VALUES PROVIDED BY WILLIAMS TRANSCONTINENTAL GAS PIPE LINE COMPANY, LLC GENERATED FROM NOAA VERTICAL DATUM WEBSITE AND VERIFIED AGAINST THE NEW JERSEY TIDAL BENCHMARK DATA. NEGLIGIBLE DIFFERENCE BETWEEN SOURCES IS ASSUMED TO BE RELATED TO SEA LEVEL RISE AND FROM NEW JERSEY DATA BEING FROM 1970'S TIDAL EPOCH DATASET.
- 9. THE MEAN LOW WATER LINE WAS DERIVED FROM SANDY HOOK, NJ TIDAL STATION DATA, CONVERTED UTILIZING NOAA V-DATUM TRANSFORMATION TOOL AND PLOTTED AGAINST BATHYMETRY DATA INDICATED ON NOAA NAUTICAL CHARTS (CHART #12327, DATED APRIL 2017). THE FOUR FEET BELOW MEAN LOW WATER LINE WAS PLOTTED AGAINST PARTIAL BATHYMETRY SURVEY BY ROGERS SURVEYING AND THE NOAA NAUTICAL CHARTS. THE MEAN LOW WATER LINE AND ELEVATION AND THE FOUR FEET BELOW MEAN LOW WATER LINE AND ELEVATION WERE PROVIDED BY ECOLOGY AND ENVIRONMENT, INC. THE FOUR FEET BELOW MEAN LOW WATER LINE DENOTES THE LINE SEPARATING INTERTIDAL ZONE (ABOVE ELEVATION -3.45, MLLW DATUM) AND SUBTIDAL SHALLOW ZONE (BELOW ELEVATION -3.45, MLLW DATUM).
- 10. DREDGING VOLUME CALCULATIONS BASED UPON CROSS-SECTIONS AND DREDGE VOLUMES PROVIDED ON PLANS ENTITLED "TRENCH CROSS-SECTION FOR PRE AND POST PIPELAY TRENCHING", LAST REVISED NOVEMBER 20, 2017, "MORGAN SHORE APPROACH HDD EXIT PIT GRADING MP 12.50", LAST REVISED JANUARY 11, 2018, "NEPTUNE CABLE CROSSING AT MP 13.88", LAST REVISED APRIL 23, 2018, "AMBROSE CHANNEL HDD EXIT PIT GRADING" AND "AMBROSE CHANNEL HDD ENTRY PIT GRADING", LAST REVISED DECEMBER 19, 2017, ALL PREPARED BY INTECSEA WORLSEY PARSONS GROUP, PROVIDED BY TRANSCONTINENTAL GAS PIPE LINE COMPANY, LLC.
- 11. APPROXIMATE ANCHOR LOCATIONS AND METHOD PROVIDED ON PLANS ENTITLED "TYPICAL ANCHOR SPREAD DRAWING", DATED MARCH 15, 2017, PREPARE BY INTECSEA WORLEY PARSONS GROUP, PROVIDED BY TRANSCONTINENTAL GAS PIPE LINE COMPANY, LLC.
- 12. FOR DESIGN, PROFILES AND DETAILS OF THE CATHODIC PROTECTION POWER CABLE AND ANODE SLED, REFER TO PLANS ENTITLED "ANODE SLED INSTALLATION AND CP HDD PLAN AND PROFILE", LAST REVISED MAY 8, 2018, PREPARED BY INTECSEA WORLEY PARSONS GROUP, PROVIDED BY TRANSCONTINENTAL GAS PIPE LINE COMPANY, LLC.
- 13. ADDITIONAL TEMPORARY OFF—SITE STAGING, STORAGE, LAND SIDE ACCESS AND GENERAL CONSTRUCTION SUPPORT IS PROVIDED AT CITY OF ELIZABETH, BLOCK 4, LOTS 1462 AND 1463 AND CITY OF JERSEY CITY, BLOCK 30501, LOT 1 AS INDICATED ON PLAN ENTITLED "NORTHEAST SUPPLY ENHANCEMENT PROJECT PROPOSED 26" MADISON LOOP PERMIT PLAN RARITAN BAY LOOP OFFSHORE STAGING AREA," DATED JUNE 8, 2018, PREPARED BY PAULUS, SOKOLOWSKI AND SARTOR, LLC.

ELEVATION TABLE				
	MEAN LOWER	NCVD 1030	NAVD 1000	
	LOW WATER	NGVD 1929	NAVD 1988	
MEAN HIGH WATER	5.27	3.40	2.36	
MEAN LOW WATER	0.57	-1.30	-2.34	
4 FT. BELOW MEAN LOW WATER	-3.45	-5.32	-6.36	

OWNER / APPLICANT

TRANSCONTINENTAL GAS PIPE LINE COMPANY, LLC 2800 POST OAK BLVD. HOUSTON, TEXAS 77056

1	10/11/19	REV NOTES ON PLANS

DESCRIPTION

I AM A DULY REGISTERED PROFESSIONAL ENGINEER UNDER THE LAY
OF THE STATE OF NEW JERSEY AND I HEREBY CERTIFY THAT THE
PROPOSED ENVIRONMENTAL DISTURBANCES SHOWN ARE ACCURATE
AND CORRESPOND WITH THE DETAILED ENGINEERING DRAWINGS.

WILLIAM SALMON, P.E.
PS&S, LLC

1433 HIGHWAY 34, SUITE A-4, WALL, NJ 07727
PROFESSIONAL ENGINEER

N.J. LIC. NO. 41319 COA NO. 24GA28032700



1433 ROUTE 34
SUITE A4
WALL, NJ 07727
PHONE: (848) 206-2626

CERTIFICATE OF AUTHORIZATION NO. 24GA28032700

ALL DIMENSIONS MUST BE VERIFIED BY THE CONTRACTOR. NOTIFY PAULUS, SOKOLOWS AND SARTOR, LLC. OF ANY CONFLICTS, ERRORS, AMBIGUITIES OR DISCREPANCIES IN TICONTRACT DRAWINGS OR SPECIFICATIONS BEFORE PROCEEDING WITH CONSTRUCTION.

ALL DIMENSIONS SHALL BE AS NOTED IN WORDS OR NUMBERS ON THE CONTRACT DRAWINGS. DO NOT SCALE THE DRAWINGS TO DETERMINE DIMENSIONS.

THESE CONTRACT DRAWINGS CONTAIN DATA INTENDED SPECIFICALLY FOR THE NOT PROJECT AND CLIENT. THEY ARE NOT INTENDED FOR USE ON EXTENSIONS OF THE PROJECT OR FOR REUSE ON ANY OTHER PROJECT.

THE COPYING AND/OR MODIFICATION OF THIS DOCUMENT OR ANY PORTION THEREW WITHOUT THE WRITTEN PERMISSION OF PAULUS, SOKOLOWSKI AND SARTOR, LLC. PROHIBITED.

UNLESS THESE DRAWINGS ARE SPECIFICALLY DESIGNATED AS "CONSTRUCTION ISSUIT THESE DRAWINGS SHALL NOTIEY THE DESIGN ENGINEER TO OBTAIN CONSTRUCTION.

COPYRIGHT 2017 PAULUS, SOKOLOWSKI AND SARTOR, LLC. — ALL RIGHTS RESERVED.

PROJECT

NORTHEAST SUPPLY
ENHANCEMENT PROJECT
PROPOSED
26" RARITAN BAY LOOP

MIDDLESEX & MONMOUTH COUNTY, NEW JERSEY

SHEET TITLE

GENERAL NOTES


PROJECT NO.: 05731.0009 DRAWN BY: JPS

SCALE: AS NOTED CHECKED BY: WS

DATE: 06/08/18 SHEET 2 OF 8

SHEET NO.

SHEET 2 OF 8

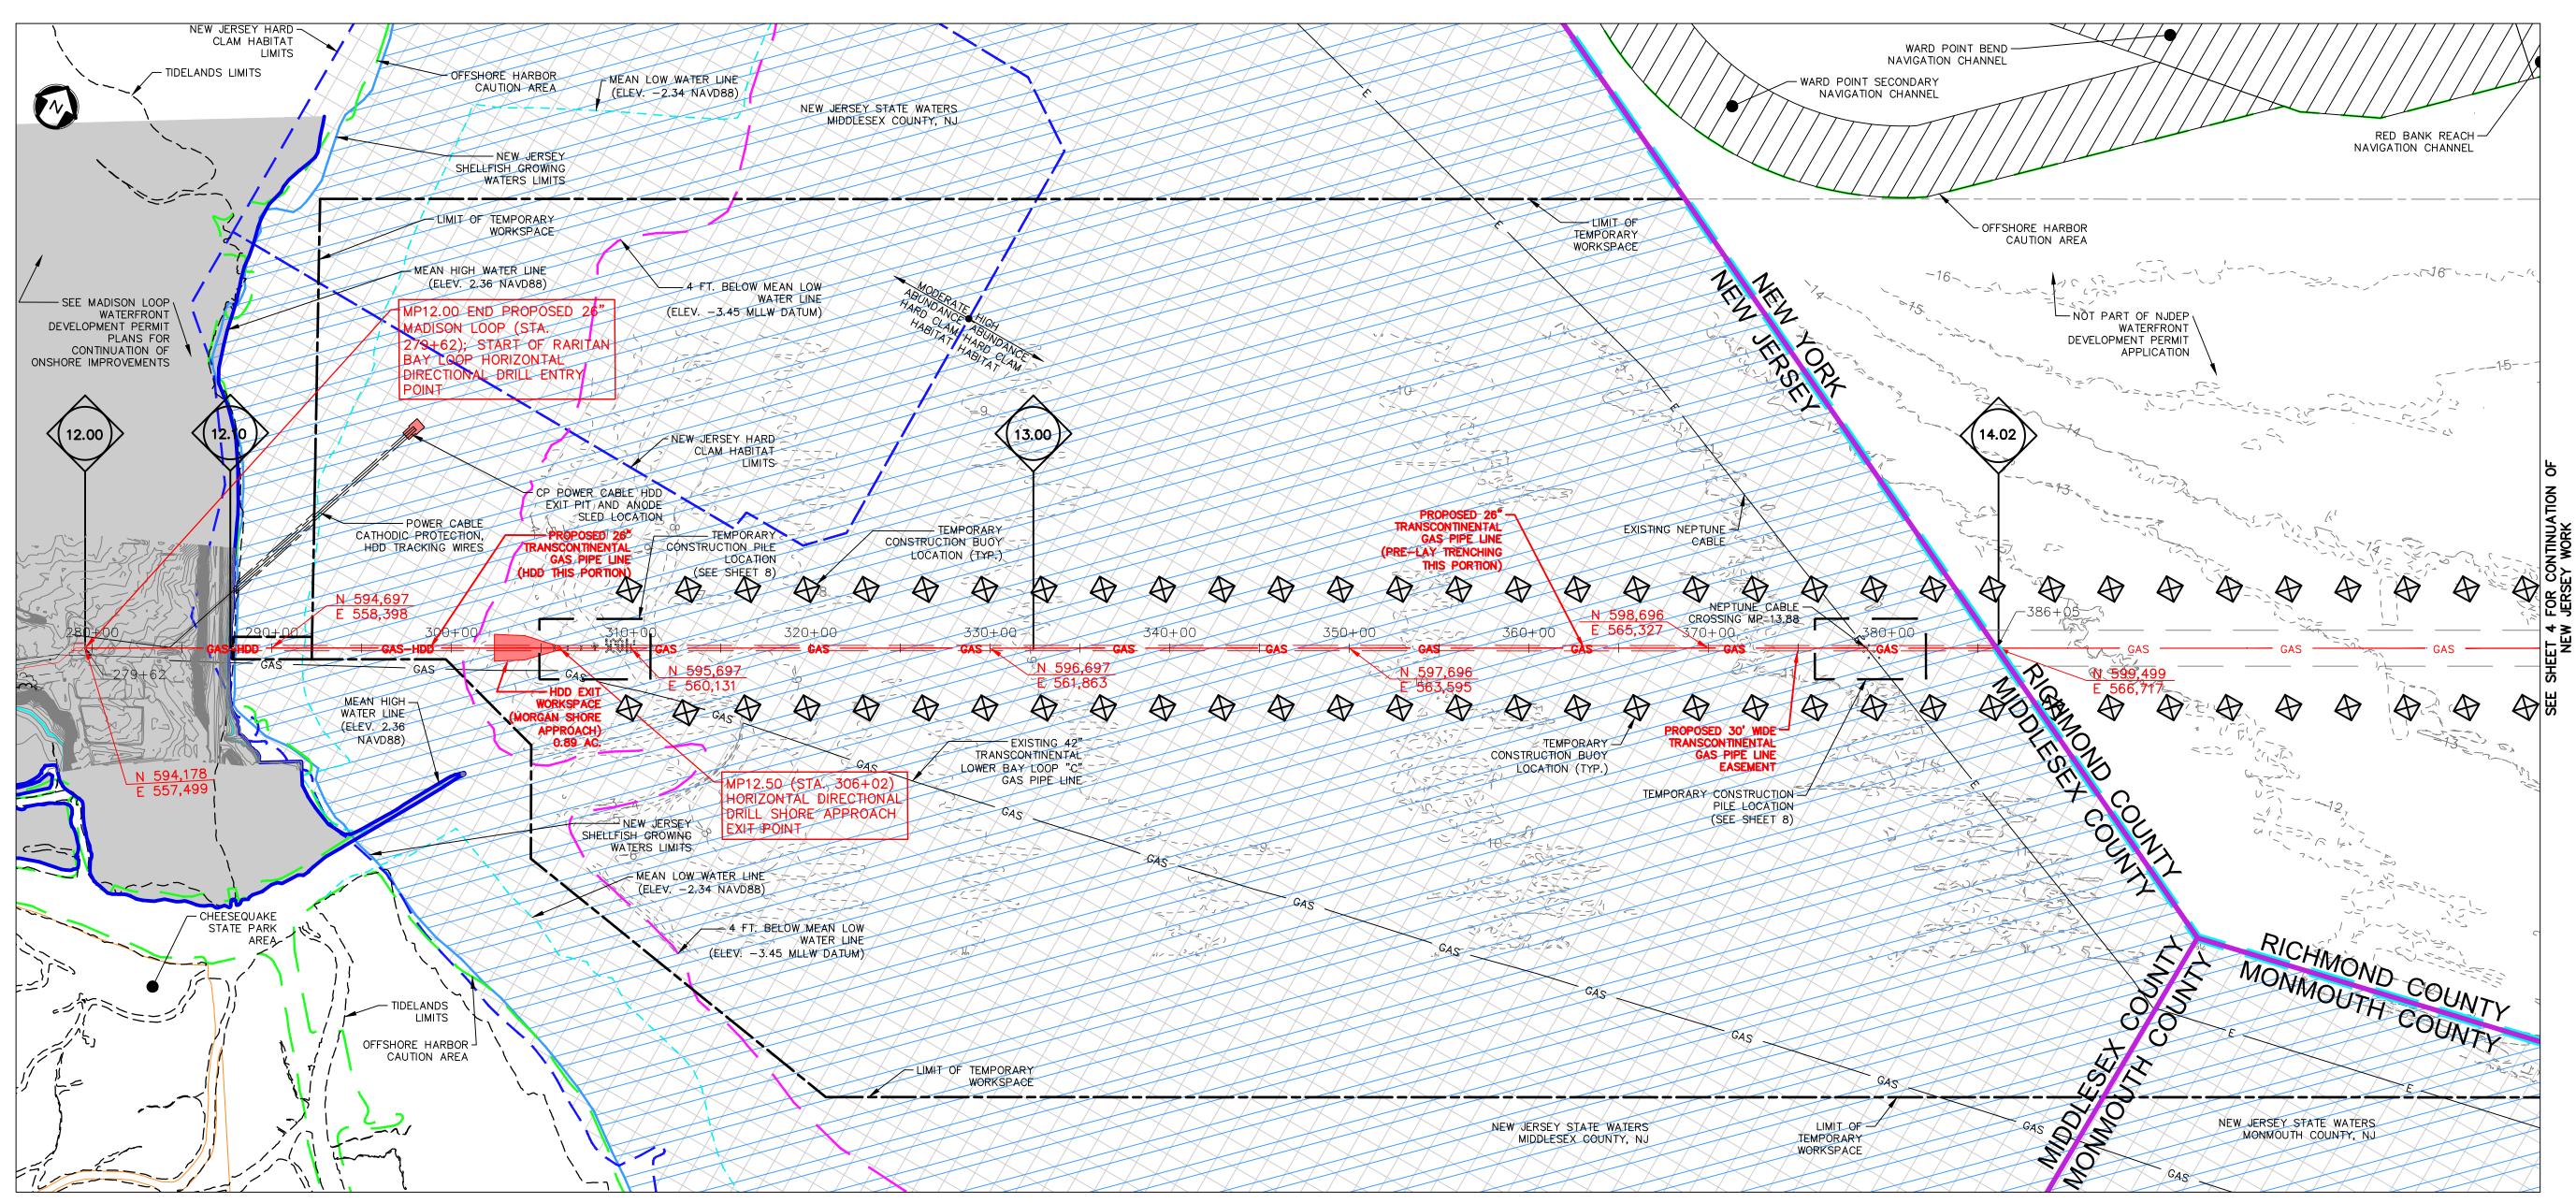

PROPOSED 26" RARITAN BAY LOOP LINE MP12.00 - MP14.02

FACILITIES ^g		
FACILITY	LAND AFFECTED DURING CONSTRUCTION NEW JERSEY (AC.)	
OFFSHORE PIPELINE PRE-LAY TRENCHING ^{a,c}	9.30	
OFFSHORE PIPELINE POST-LAY TRENCHING ^a	3.51	
OFFSHORE CP ^h	0.15	
LAY-DOWN AREA FOR PULL-BACK STRING (AMBROSE CROSSING)	0.34	
NEPTUNE CABLE CROSSING	0.35	
SUPPORT VESSEL, PIPELAY BARGE, AND DREDGE BARGE/CRANE BARGE ANCHOR FOOTPRINT ^d	0.93	
ANCHOR CABLE SWEEP ^e	0.24	
HDD EXIT WORKSPACE (MORGAN SHORE APPROACH HDD CROSSING) ^b	0.89	
HDD ENTRANCE WORKSPACE EAST (AMBROSE CHANNEL CROSSING) ^b	1.78	
HDD EXIT WORKSPACE WEST (AMBROSE CHANNEL CROSSING) ^b	1.13	
MARINE SUPPORT BARGE, LIFT BARGE, AND DREDGE BARGE SPUD DISTURBANCE ^f	0.90	
PILE DISTURBANCE FOR TEMPORARY FIXED PLATFORM, HDD SUPPORT, AND SHALLOW	0.02	
PIPELAYING OPERATIONS ^{i,j}	19 54	

SUMMARY OF DIRECT IMPACTS FOR OFFSHORE PIPELINE

	DREDGE VOLUME CALCULATION			
M.P.	DESCRIPTION	VOLUME (CY)		
CP POWER	ANODE SLED EXCAVATION PIT - CLAMSHELL DREDGING	461		
12.50	HDD PIT EXCAVATION - CLAMSHELL DREDGING	9,931		
12.50-13.88	CLAMSHELL EXCAVATION - PRE LAY SHALLOW AREA TRENCHING - TYPE 1 (52 ft. WIDE)	57,894		
13.88	HAND JETTING ABOVE NEPTUNE CABLE (62 FT. WIDE)	1,676		
13.88-14.02	CLAMSHELL EXCAVATION - PRE LAY SHALLOW AREA DREDGE - TYPE 1 (52 ft. WIDE)	5,974		
26.55-29.52	JET TRENCHER POST LAY METHOD (9 FT. WIDE)	51,548		
29.52	HDD EXIT PIT EXCAVATION - CLAMSHELL DREDGING	14,050		
30.40	HDD ENTRY PIT EXCAVATION - CLAMSHELL DREDGING	32,450		
30.40-30.64	JET TRENCHER POST LAY METHOD (9 FT. WIDE)	4,187		
TOTAL		178,171		

DIRECT IMPACT NOTES:

- b. INCLUDES PIT EXCAVATION AND PLACEMENT AREA AT HDD ENTRY/EXIT POINTS.
- c. INCLUDES LAY-DOWN AREA FOR PULL-BACK STRING (MORGAN SHORE APPROACH HDD CROSSING).
 d. ANCHOR FOOTPRINTS ASSUMED TO HAVE IMPACT AREAS OF 10' X 20' PER ANCHOR.


TWENTY-TWO 24-INCH DIAMETER PILES, TWELVE 34-INCH DIAMETER PILES, EIGHT 60-INCH DIAMETER PILES.


- e. MID-LINE BUOYS ASSUMED TO BE USED TO MINIMIZE ANCHOR CABLE SWEEP IMPACT AND FOR OBSTACLE AVOIDANCE WHERE NECESSARY.

 f. SPUD IMPACT AREA ASSUMED TO BE 10' X 10'.
- g. FOLLOWING INSTALLATION NO ROUTINE BOTTOM IMPACTS ASSOCIATED WITH OPERATIONS ARE ANTICIPATED. FUTURE MAINTENANCE IS
 EXPECTED TO BE MINIMAL BASED ON THE OPERATIONAL LIFE OF THE PIPELINE.
 h. ONLY THE IMPACTS ASSOCIATED WITH THE OFFSHORE CATHODIC PROTECTION ANODE SLED EXCAVATION AND FOUR—POINT SPUDDED BARGE
- h. ONLY THE IMPACTS ASSOCIATED WITH THE OFFSHORE CATHODIC PROTECTION ANODE SLED EXCAVATION AND FOUR—POINT SPUDDED BARGI
 USED FOR INSTALLATION LIES WITHIN EXISTING INTERTIDAL AREAS.
 i. PILE DISTURBANCE AREA INCLUDES IMPACT ASSOCIATED WITH PILE DRIVING OUTSIDE OF AREAS TO BE IMPACTED DURING EXCAVATION.
 i. PILE DISTURBANCE AREA INCLUDES THE FOLLOWING PILES: EIGHTEEN 36—INCH DIAMETER PILES, TWENTY—FOUR 48—INCH DIAMETER PILES.


NOTES:

- 1. THE FOLLOWING COASTAL ZONE MANAGEMENT SPECIAL AREAS ARE NOT LOCATED WITHIN THE REGION SHOWN ON THIS SHEET: SURF CLAM, PRIME FISHING, FINFISH MIGRATORY PATHWAYS, SUBMERGED VEGETATION HABITATS, NAVIGATION CHANNELS, CANALS, INLETS, MARINA MOORINGS, PORTS, WET BORROW PITS, DUNES, OVERWASH AREAS, COASTAL HIGH HAZARD, EROSION HAZARD, BARRIER ISLAND CORRIDOR, BAY ISLANDS, BEACHES, FILLED WATER'S EDGES, EXISTING LAGOON EDGES, FLOOD HAZARD AREAS, RIPARIAN ZONES, WETLANDS, WETLAND BUFFERS, COASTAL BLUFFS, INTERMITTENT STREAM CORRIDORS, FARMLAND CONSERVATION AREAS, STEEP SLOPES, DRY BORROW PITS, HISTORIC AND ARCHAEOLOGICAL RESOURCES, SPECIMEN TREES, PUBLIC OPEN SPACES, SPECIAL HAZARD AREAS, EXCLUDED FEDERAL LANDS, SPECIAL URBAN AREAS, PINELANDS NATIONAL RESERVE AND PINELANDS PROTECTION AREAS, HACKENSACK MEADOWLANDS DISTRICT, WILD AND SCENIC RIVER CORRIDORS, GEODETIC CONTROL REFERENCE MARKS, HUDSON RIVER WATERFRONT AREAS, ATLANTIC CITY, LANDS AND WATERS SUBJECT TO PUBLIC TRUST RIGHTS, OR DREDGED MATERIAL MANAGEMENT AREAS.
- 2. DREDGING VOLUME CALCULATIONS BASED UPON CROSS-SECTIONS AND DREDGE VOLUMES PROVIDED ON PLANS ENTITLED "TRENCH CROSS-SECTION FOR PRE AND POST PIPELAY TRENCHING", LAST REVISED NOVEMBER 20, 2017, "NEPTUNE CABLE CROSSING AT MP 13.88", LAST REVISED APRIL 23, 2018, "AMBROSE CHANNEL HDD EXIT PIT GRADING" AND "AMBROSE CHANNEL HDD ENTRY PIT GRADING", LAST REVISED DECEMBER 19, 2017, "ANODE SLED INSTALLATION AND CP HDD PLAN AND PROFILE", LAST REVISED MAY 8, 2018, AND "MORGAN SHORE APPROACH HDD PLAN AND PROFILE", LAST REVISED JANUARY 11, 2018, PREPARED BY INTECSEA WORLEY PARSONS GROUP AND PROVIDED BY TRANSCONTINENTAL GAS PIPE LINE COMPANY, LLC. VOLUMES ARE INTERPOLATED FROM "MP RANGE AND DREDGE VOLUME" TABLES ON ABOVE—REFERENCED PLANS.
- 3. LOCATIONS OF PROPOSED TEMPORARY CONSTRUCTION PILE AND BUOY LOCATIONS ARE BASED ON PLANS ENTITLED "TEMPORARY CONSTRUCTION PILES MARKING PLAN FOR AMBROSE HDD WEST AND EAST APPROACH" AND "TEMPORARY CONSTRUCTION PILES AND BUOYS MARKING PLAN FOR MORGAN SHORE APPROACH", DATED MAY 9, 2018, PREPARED BY INTECSEA WORLEY PARSONS GROUP AND PROVIDED BY TRANSCONTINENTAL GAS PIPE LINE COMPANY, LLC.

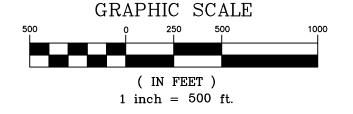

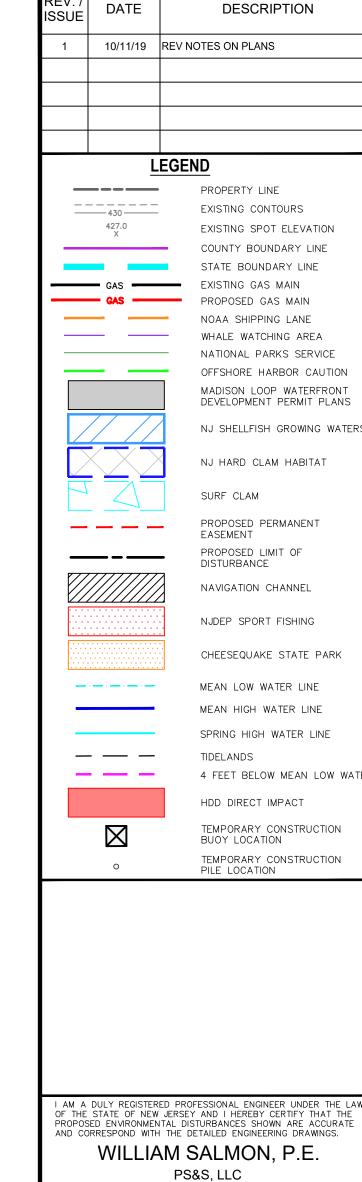

PS&S, LLC 1433 HIGHWAY 34, SUITE A-4, WALL, NJ 07727 PROFESSIONAL ENGINEER

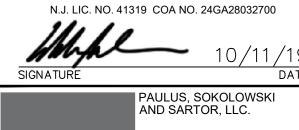

1433 ROUTE 34
SUITE A4
WALL, NJ 07727
PHONE: (848) 206-2626
CERTIFICATE OF AUTHORIZATION NO. 24GA28032700

ALL DIMENSIONS MUST BE VERIFIED BY THE CONTRACTOR. NOTIFY PAULUS, SOKOLON AND SARTOR, LLC. OF ANY CONFLICTS, ERRORS, AMBIGUITIES OR DISCREPANCIES IN CONTRACT DRAWINGS OR SPECIFICATIONS BEFORE PROCEEDING WITH CONSTRUCTION.

ALL DIMENSIONS SHALL BE AS NOTED IN WORDS OR NUMBERS ON THE CONTR DRAWINGS. DO NOT SCALE THE DRAWINGS TO DETERMINE DIMENSIONS.

THESE CONTRACT DRAWINGS CONTAIN DATA INTENDED SPECIFICALLY FOR THE NOT PROJECT AND CLIENT. THEY ARE NOT INTENDED FOR USE ON EXTENSIONS OF PROJECT OR FOR REUSE ON ANY OTHER PROJECT.

THE COPYING AND/OR MODIFICATION OF THIS DOCUMENT OR ANY PORTION THER WITHOUT THE WRITTEN PERMISSION OF PAULUS, SOKOLOWSKI AND SARTOR, LLC PROHIBITED.

UNLESS THESE DRAWINGS ARE SPECIFICALLY DESIGNATED AS "CONSTRUCTION ISS THESE DRAWINGS SHALL NOTIFY THE DESIGN ENGINEER TO OBTAIN CONSTRUCT

OPYRIGHT 2017 PAULUS, SOKOLOWSKI AND SARTOR, LLC. — ALL RIGHTS RESERVED.

PROJECT

NORTHEAST SUPPLY
ENHANCEMENT PROJECT
PROPOSED
26" RARITAN BAY LOOP

MIDDLESEX & MONMOUTH COUNTY, NEW JERSEY

SHEET TITLE

WATERFRONT DEVELOPMENT PERMIT PLAN MP 12.00 - 14.02


PROJECT NO	D.: 05731.0009	DRAWN I	BY:	JPS
SCALE:	AS NOTED	CHECKE	D BY: W	/S
DATE:	06/08/18	SHEET	3 OF	8


.

O.:

SHEET NO.

3

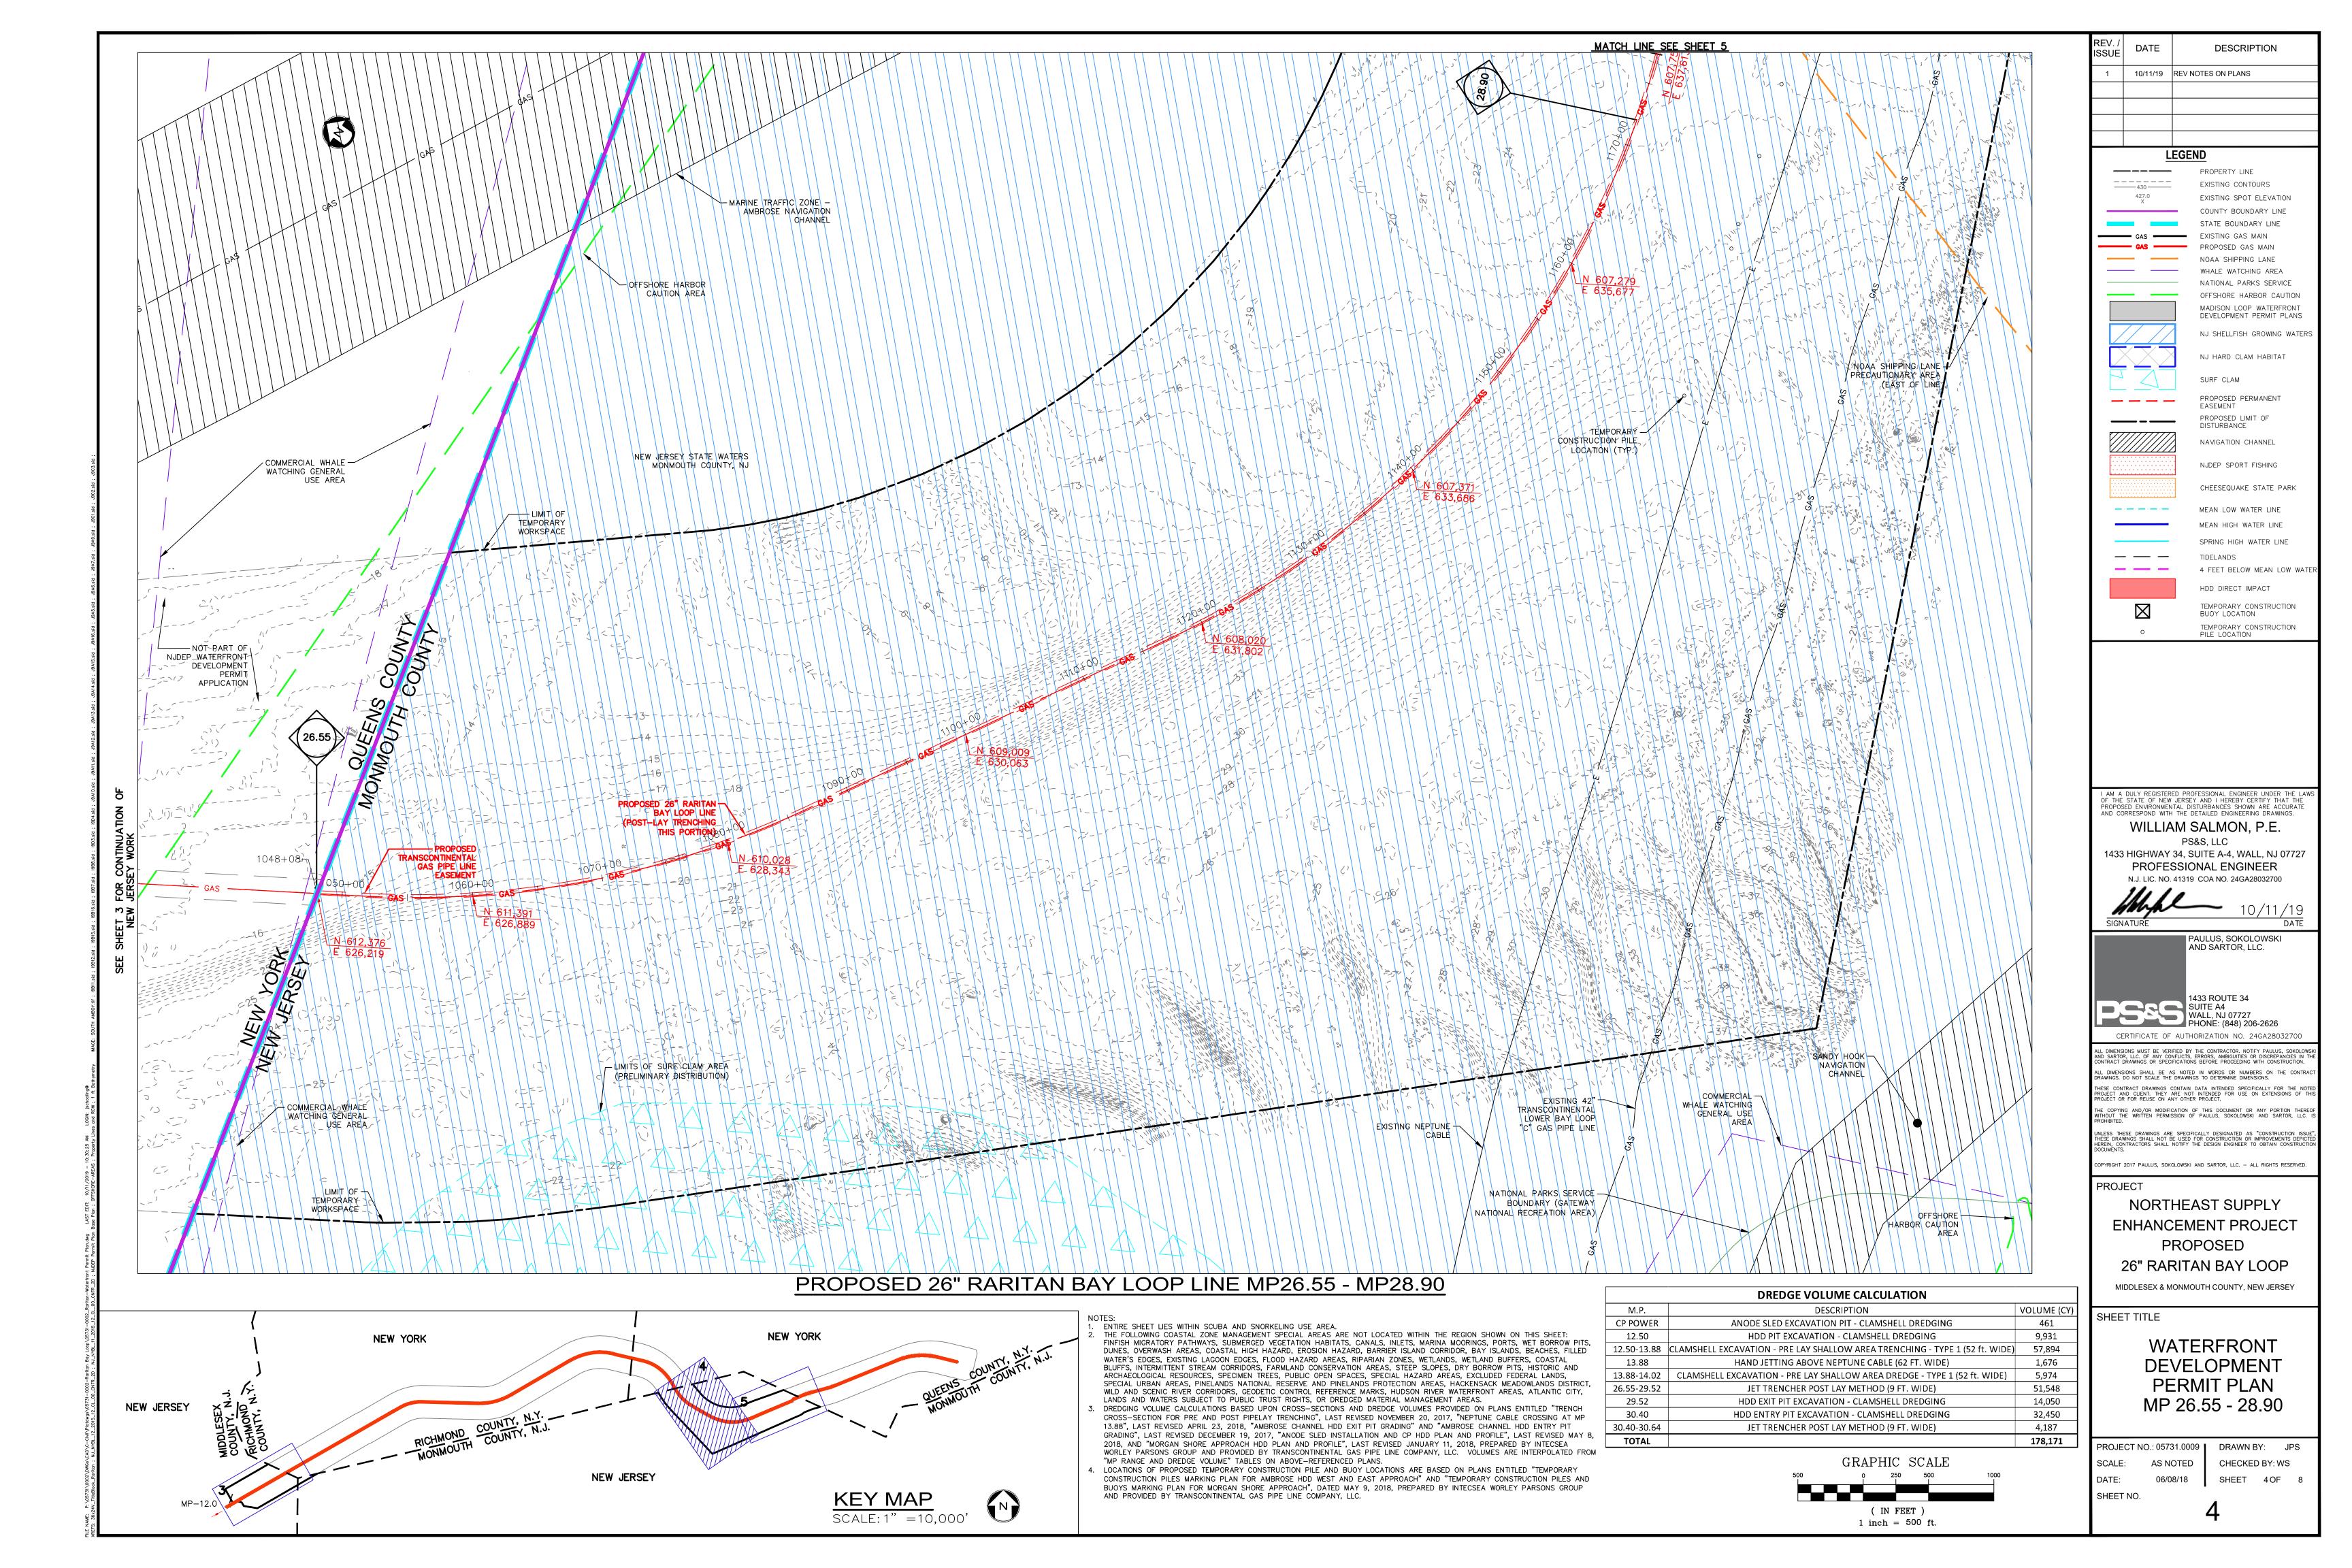

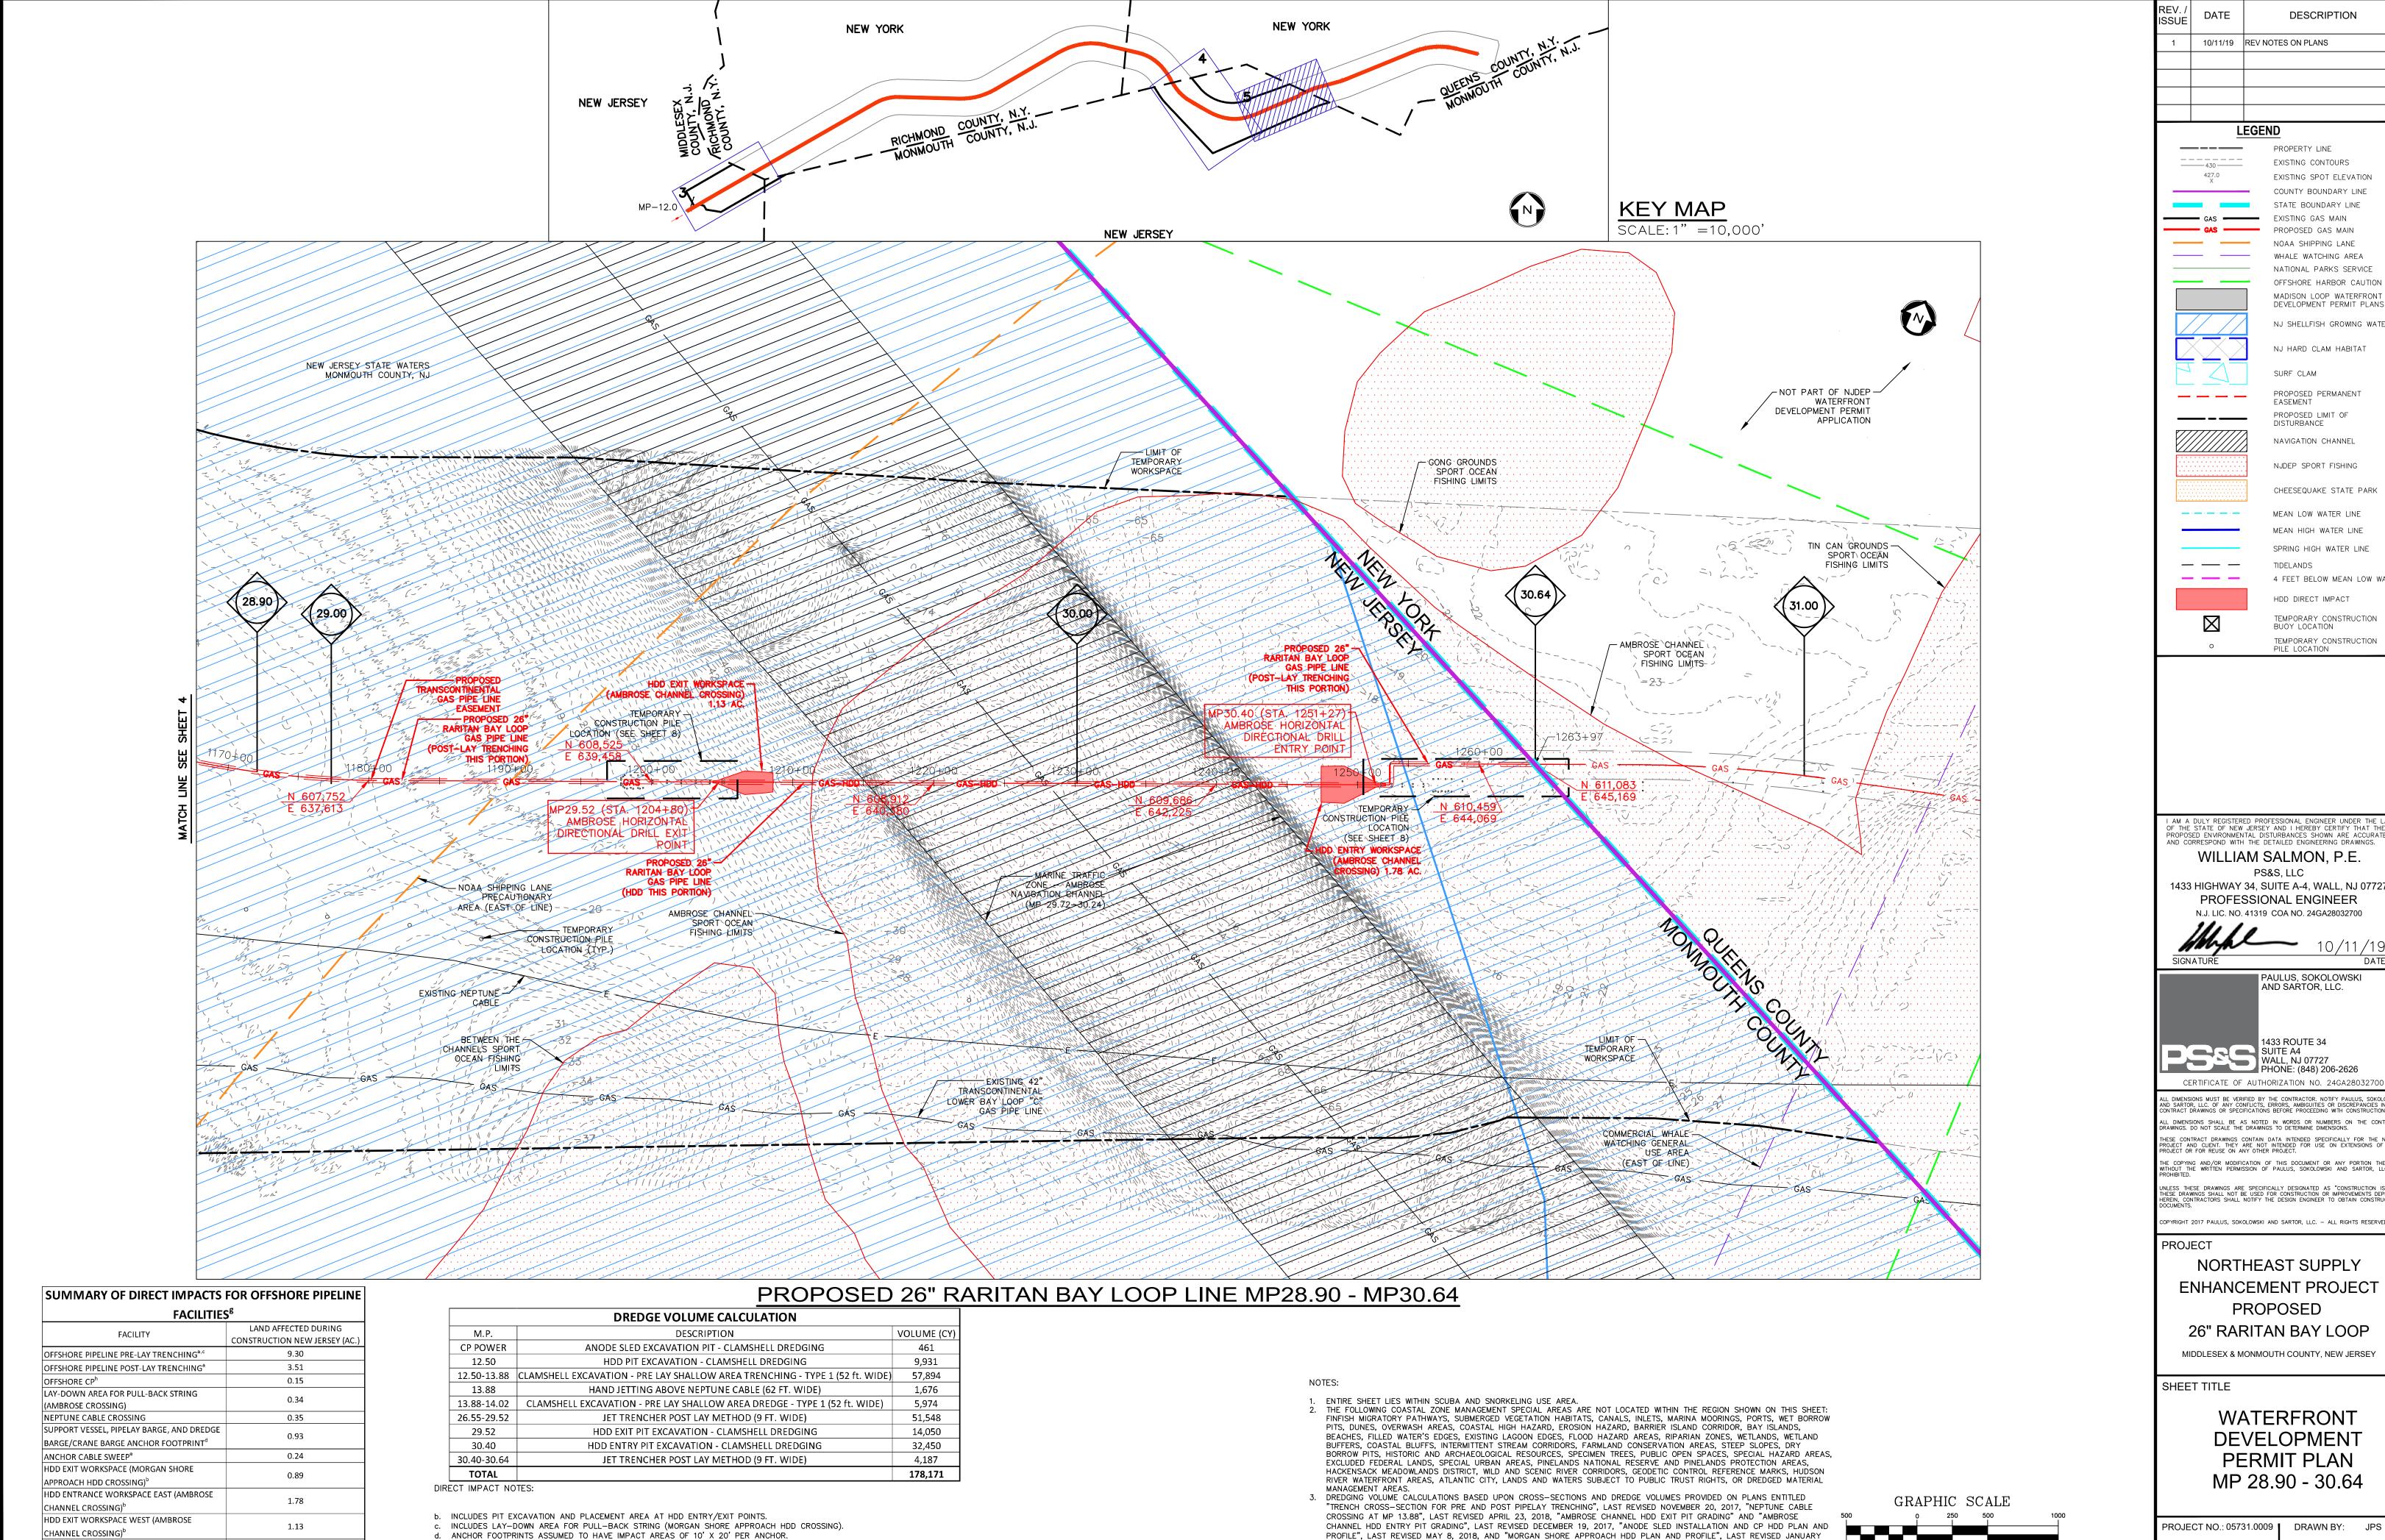

11, 2018, PREPARED BY INTECSEA WORLEY PARSONS GROUP AND PROVIDED BY TRANSCONTINENTAL GAS PIPE LINE COMPANY,

LLC. VOLUMES ARE INTERPOLATED FROM "MP RANGE AND DREDGE VOLUME" TABLES ON ABOVE-REFERENCED PLANS.

"TEMPORARY CONSTRUCTION PILES MARKING PLAN FOR AMBROSE HDD WEST AND EAST APPROACH" AND "TEMPORARY

CONSTRUCTION PILES AND BUOYS MARKING PLAN FOR MORGAN SHORE APPROACH", DATED MAY 9, 2018, PREPARED BY

4. LOCATIONS OF PROPOSED TEMPORARY CONSTRUCTION PILE AND BUOY LOCATIONS ARE BASED ON PLANS ENTITLED

INTECSEA WORLEY PARSONS GROUP AND PROVIDED BY TRANSCONTINENTAL GAS PIPE LINE COMPANY, LLC.

MID-LINE BUOYS ASSUMED TO BE USED TO MINIMIZE ANCHOR CABLE SWEEP IMPACT AND FOR OBSTACLE AVOIDANCE WHERE NECESSARY.

FOLLOWING INSTALLATION NO ROUTINE BOTTOM IMPACTS ASSOCIATED WITH OPERATIONS ARE ANTICIPATED. FUTURE MAINTENANCE IS

EXPECTED TO BE MINIMAL BASED ON THE OPERATIONAL LIFE OF THE PIPELINE.

h. ONLY THE IMPACTS ASSOCIATED WITH THE OFFSHORE CATHODIC PROTECTION ANODE SLED EXCAVATION AND FOUR—POINT SPUDDED BARGE

PILE DISTURBANCE AREA INCLUDES IMPACT ASSOCIATED WITH PILE DRIVING OUTSIDE OF AREAS TO BE IMPACTED DURING EXCAVATION. PILE DISTURBANCE AREA INCLUDES THE FOLLOWING PILES: EIGHTEEN 36-INCH DIAMETER PILES, TWENTY-FOUR 48-INCH DIAMETER PILES, TWENTY-TWO 24-INCH DIAMETER PILES,

SPUD IMPACT AREA ASSUMED TO BE 10' X 10'.

USED FOR INSTALLATION LIES WITHIN EXISTING INTERTIDAL AREAS.

MARINE SUPPORT BARGE, LIFT BARGE, AND

PILE DISTURBANCE FOR TEMPORARY FIXED

PLATFORM, HDD SUPPORT, AND SHALLOW

0.02

19.54

DREDGE BARGE SPUD DISTURBANCE

PIPELAYING OPERATIONS^{i,j}

SURF CLAM PROPOSED PERMANENT PROPOSED LIMIT OF DISTURBANCE NAVIGATION CHANNEL NJDEP SPORT FISHING CHEESEQUAKE STATE PARK MEAN LOW WATER LINE MEAN HIGH WATER LINE SPRING HIGH WATER LINE TIDELANDS 4 FEET BELOW MEAN LOW WATE HDD DIRECT IMPACT TEMPORARY CONSTRUCTION BUOY LOCATION TEMPORARY CONSTRUCTION

DESCRIPTION

EXISTING CONTOURS EXISTING SPOT ELEVATION COUNTY BOUNDARY LINE

STATE BOUNDARY LINE

WHALE WATCHING AREA NATIONAL PARKS SERVICE OFFSHORE HARBOR CAUTION MADISON LOOP WATERFRONT DEVELOPMENT PERMIT PLANS

NJ SHELLFISH GROWING WATER

NJ HARD CLAM HABITAT

WILLIAM SALMON, P.E. PS&S, LLC

1433 HIGHWAY 34, SUITE A-4, WALL, NJ 07727 PROFESSIONAL ENGINEER N.J. LIC. NO. 41319 COA NO. 24GA28032700

AND SARTOR, LLC.

1433 ROUTE 34 PSSS 1433 ROUTE 34 SUITE A4 WALL, NJ 07727 PHONE: (848) 206-2626

ILL DIMENSIONS MUST BE VERIFIED BY THE CONTRACTOR. NOTIFY PAULUS, SOKOLO ND SARTOR, LLC. OF ANY CONFLICTS, ERRORS, AMBIGUITIES OR DISCREPANCIES IN ONTRACT DRAWINGS OR SPECIFICATIONS BEFORE PROCEEDING WITH CONSTRUCTION. THESE CONTRACT DRAWINGS CONTAIN DATA INTENDED SPECIFICALLY FOR THE NO PROJECT AND CLIENT. THEY ARE NOT INTENDED FOR USE ON EXTENSIONS OF T PROJECT OR FOR REUSE ON ANY OTHER PROJECT. INLESS THESE DRAWINGS ARE SPECIFICALLY DESIGNATED AS "CONSTRUCTION ISS HESE DRAWINGS SHALL NOT BE USED FOR CONSTRUCTION OR IMPROVEMENTS DEPI-IEREIN, CONTRACTORS SHALL NOTIFY THE DESIGN ENGINEER TO OBTAIN CONSTRUC

OPYRIGHT 2017 PAULUS, SOKOLOWSKI AND SARTOR, LLC. - ALL RIGHTS RESERVED.

ENHANCEMENT PROJECT PROPOSED 26" RARITAN BAY LOOP

MIDDLESEX & MONMOUTH COUNTY, NEW JERSEY

WATERFRONT DEVELOPMENT PERMIT PLAN MP 28.90 - 30.64


PROJECT NO.: 05731.0009 DRAWN BY: JPS AS NOTED DATE: 06/08/18


SHEET NO.


(IN FEET)

1 inch = 500 ft.

CHECKED BY: WS SHEET 5OF 8

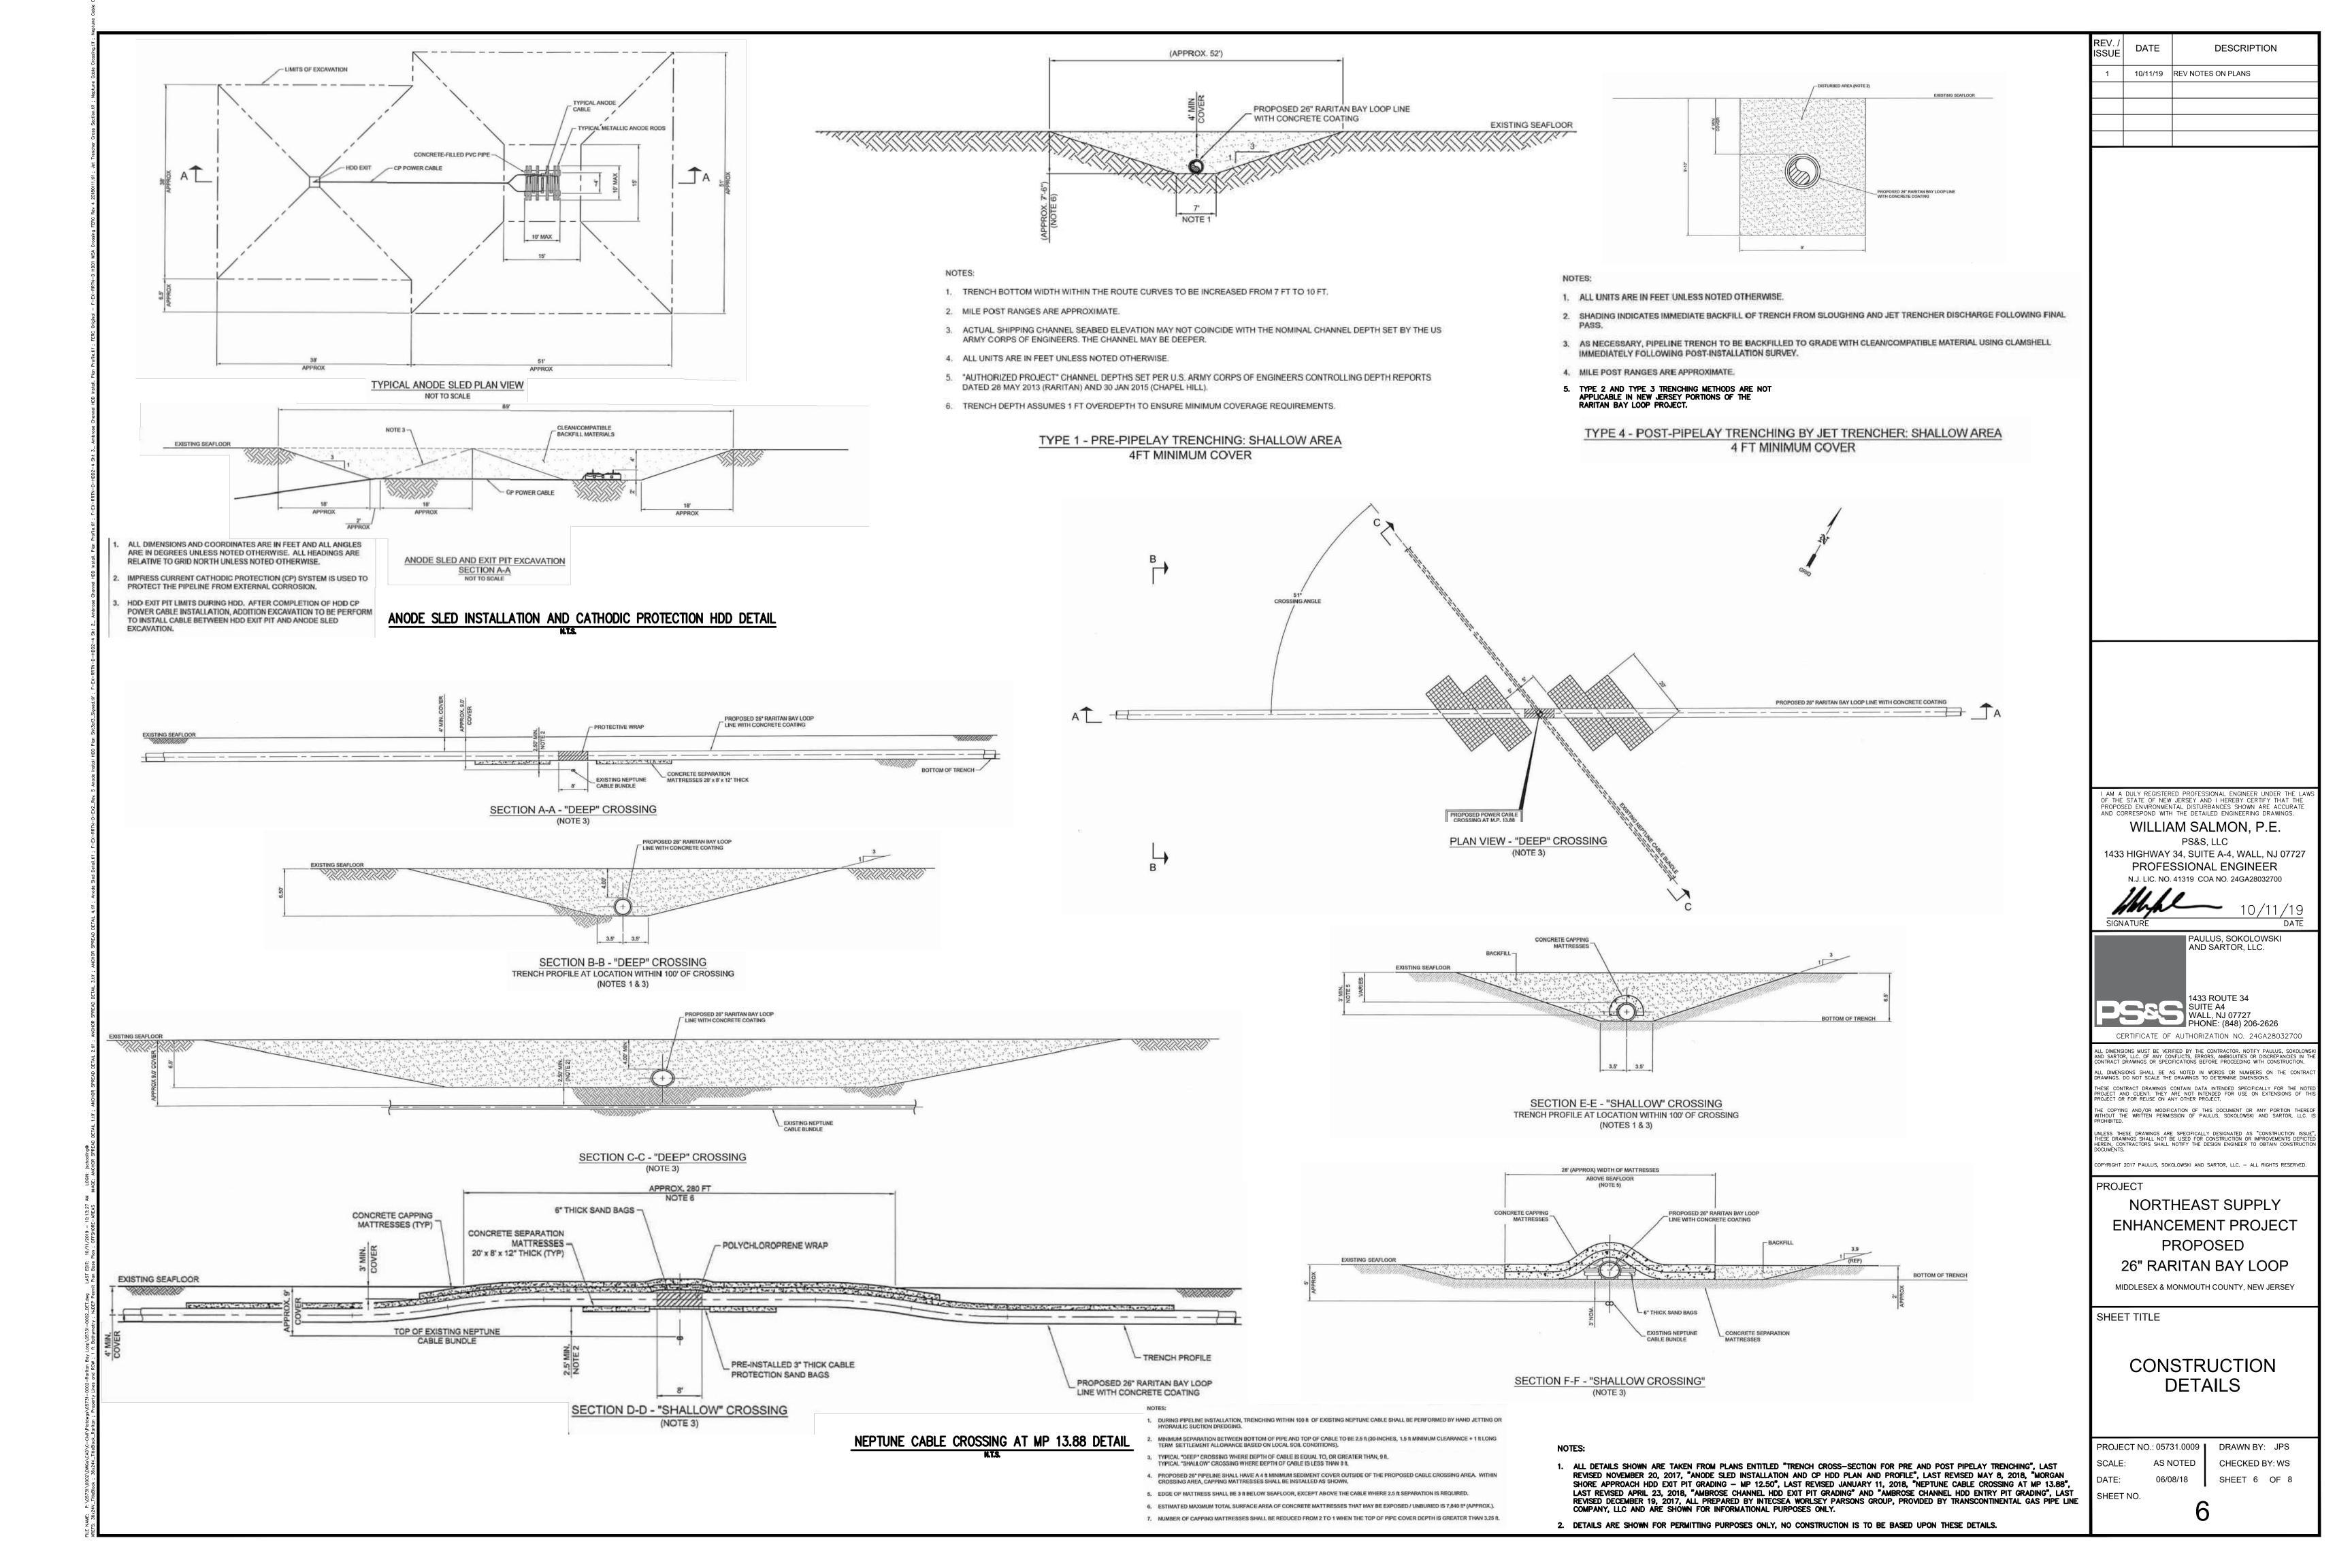

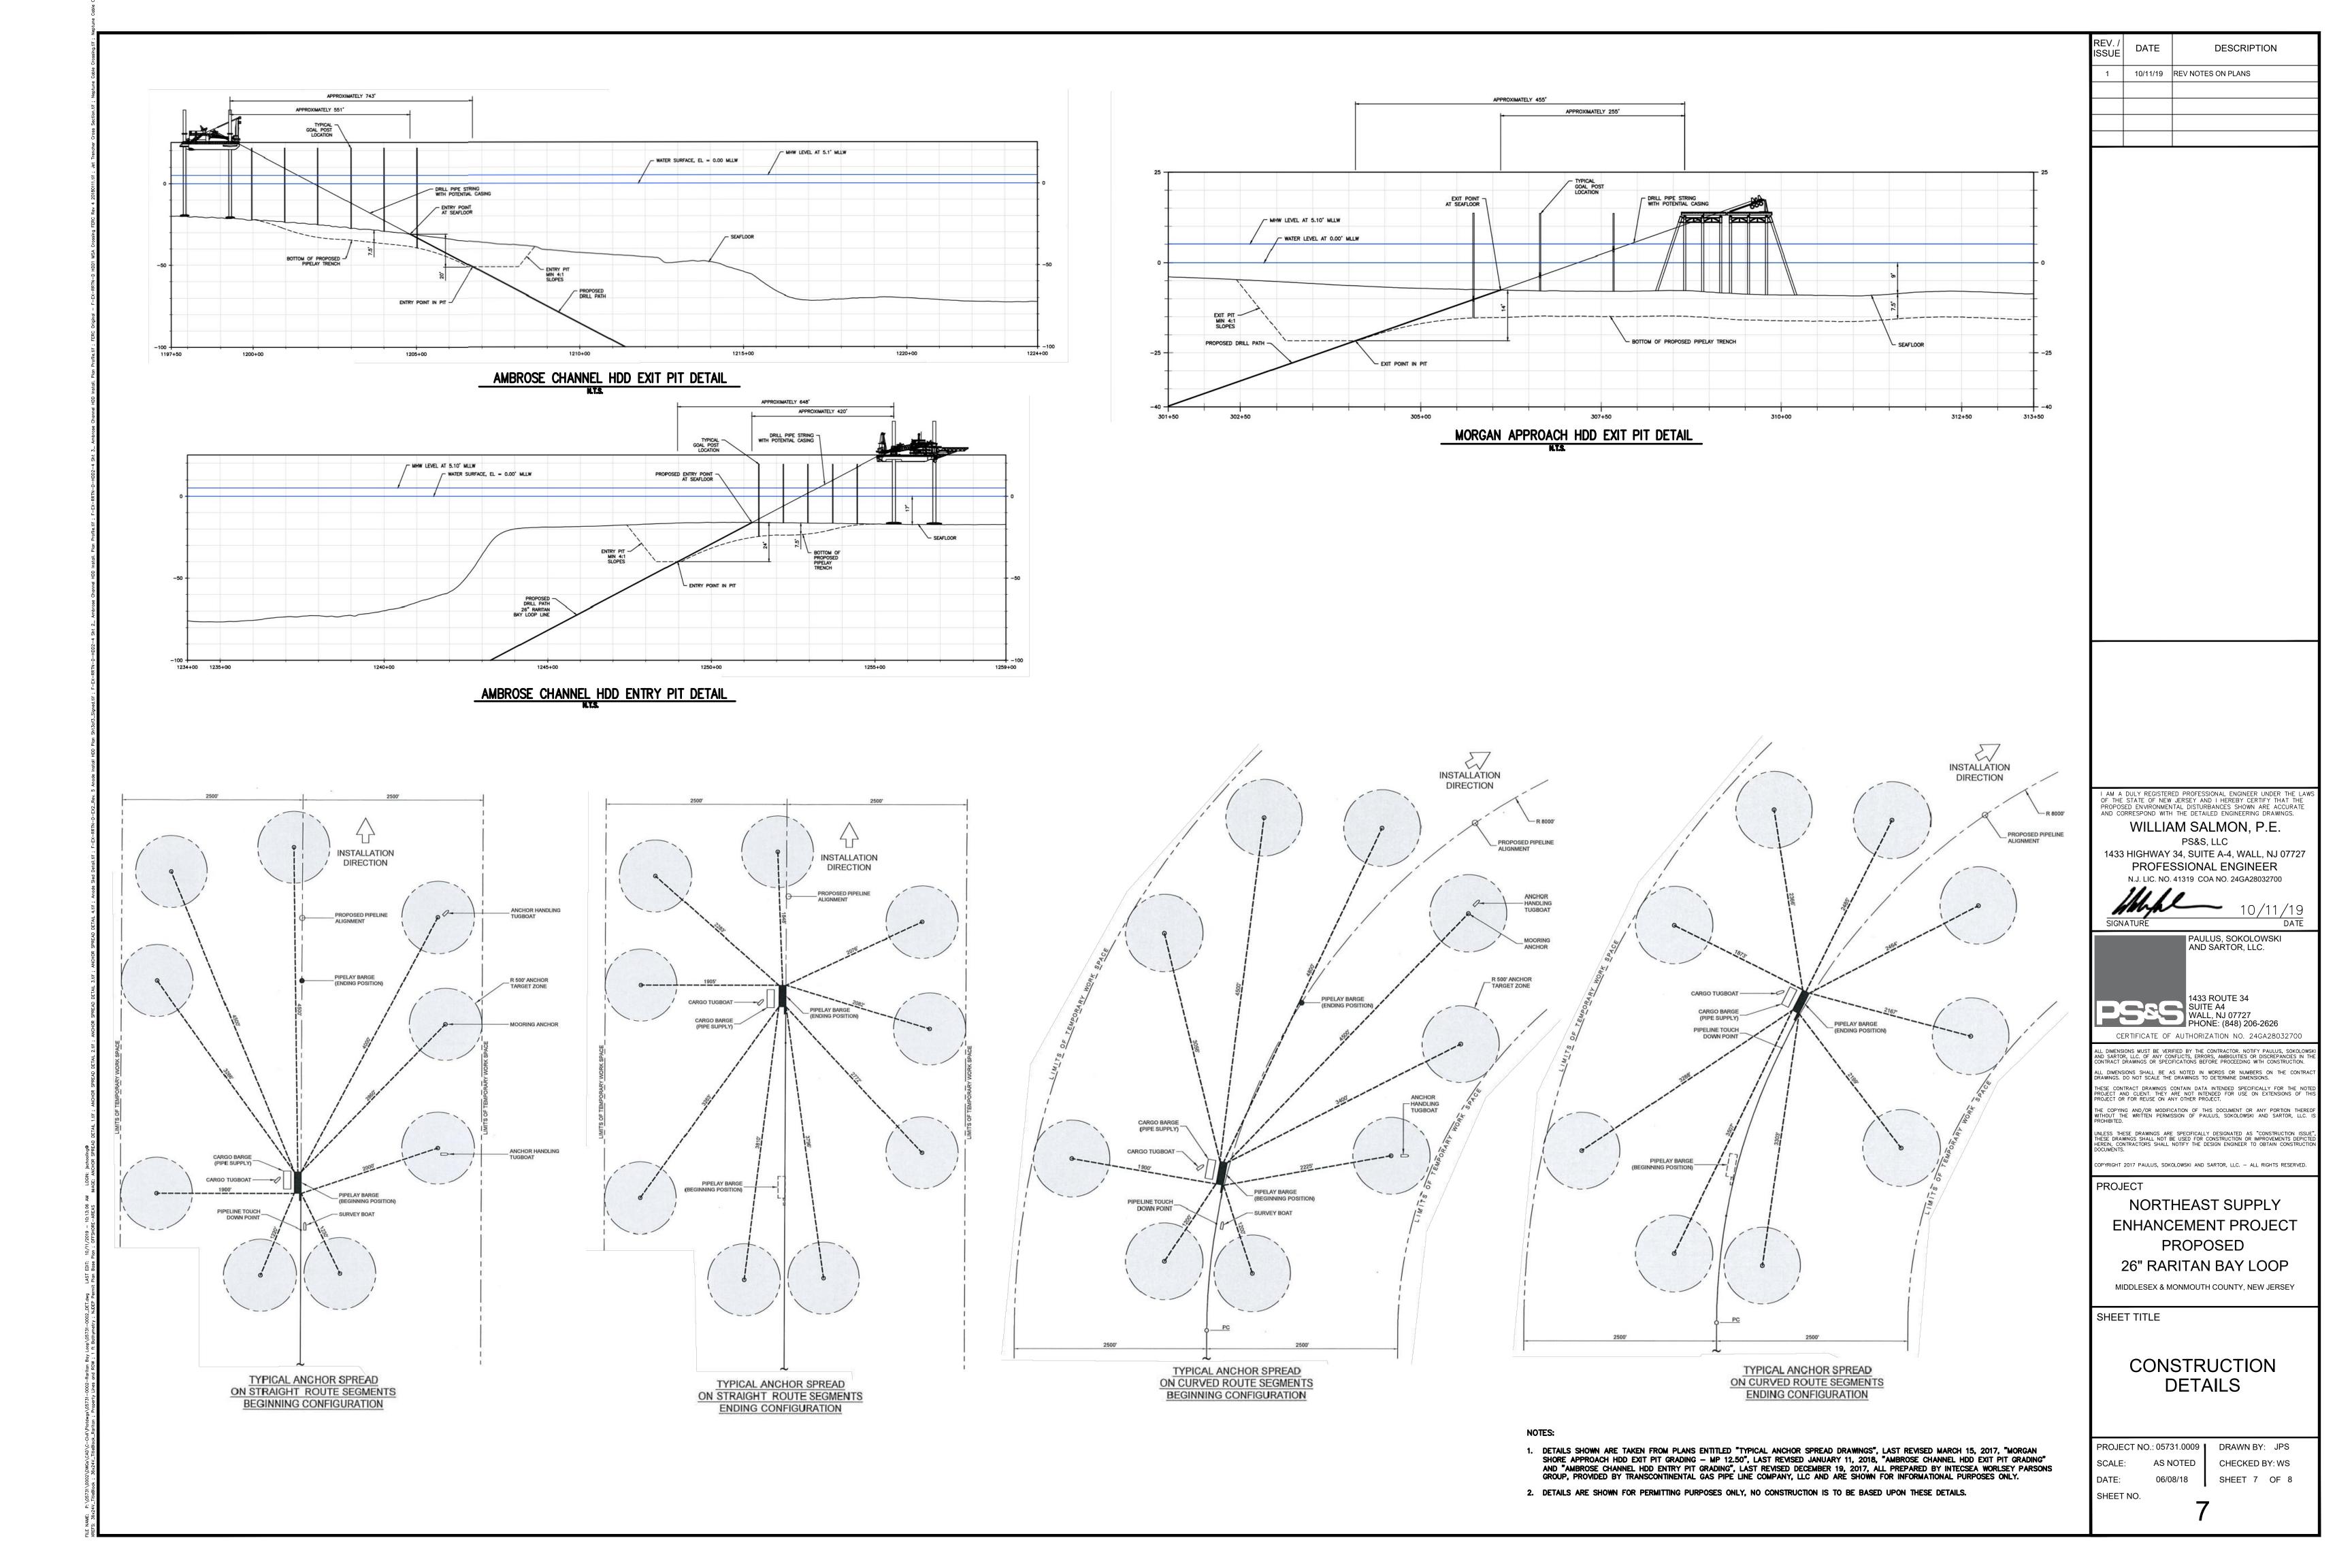

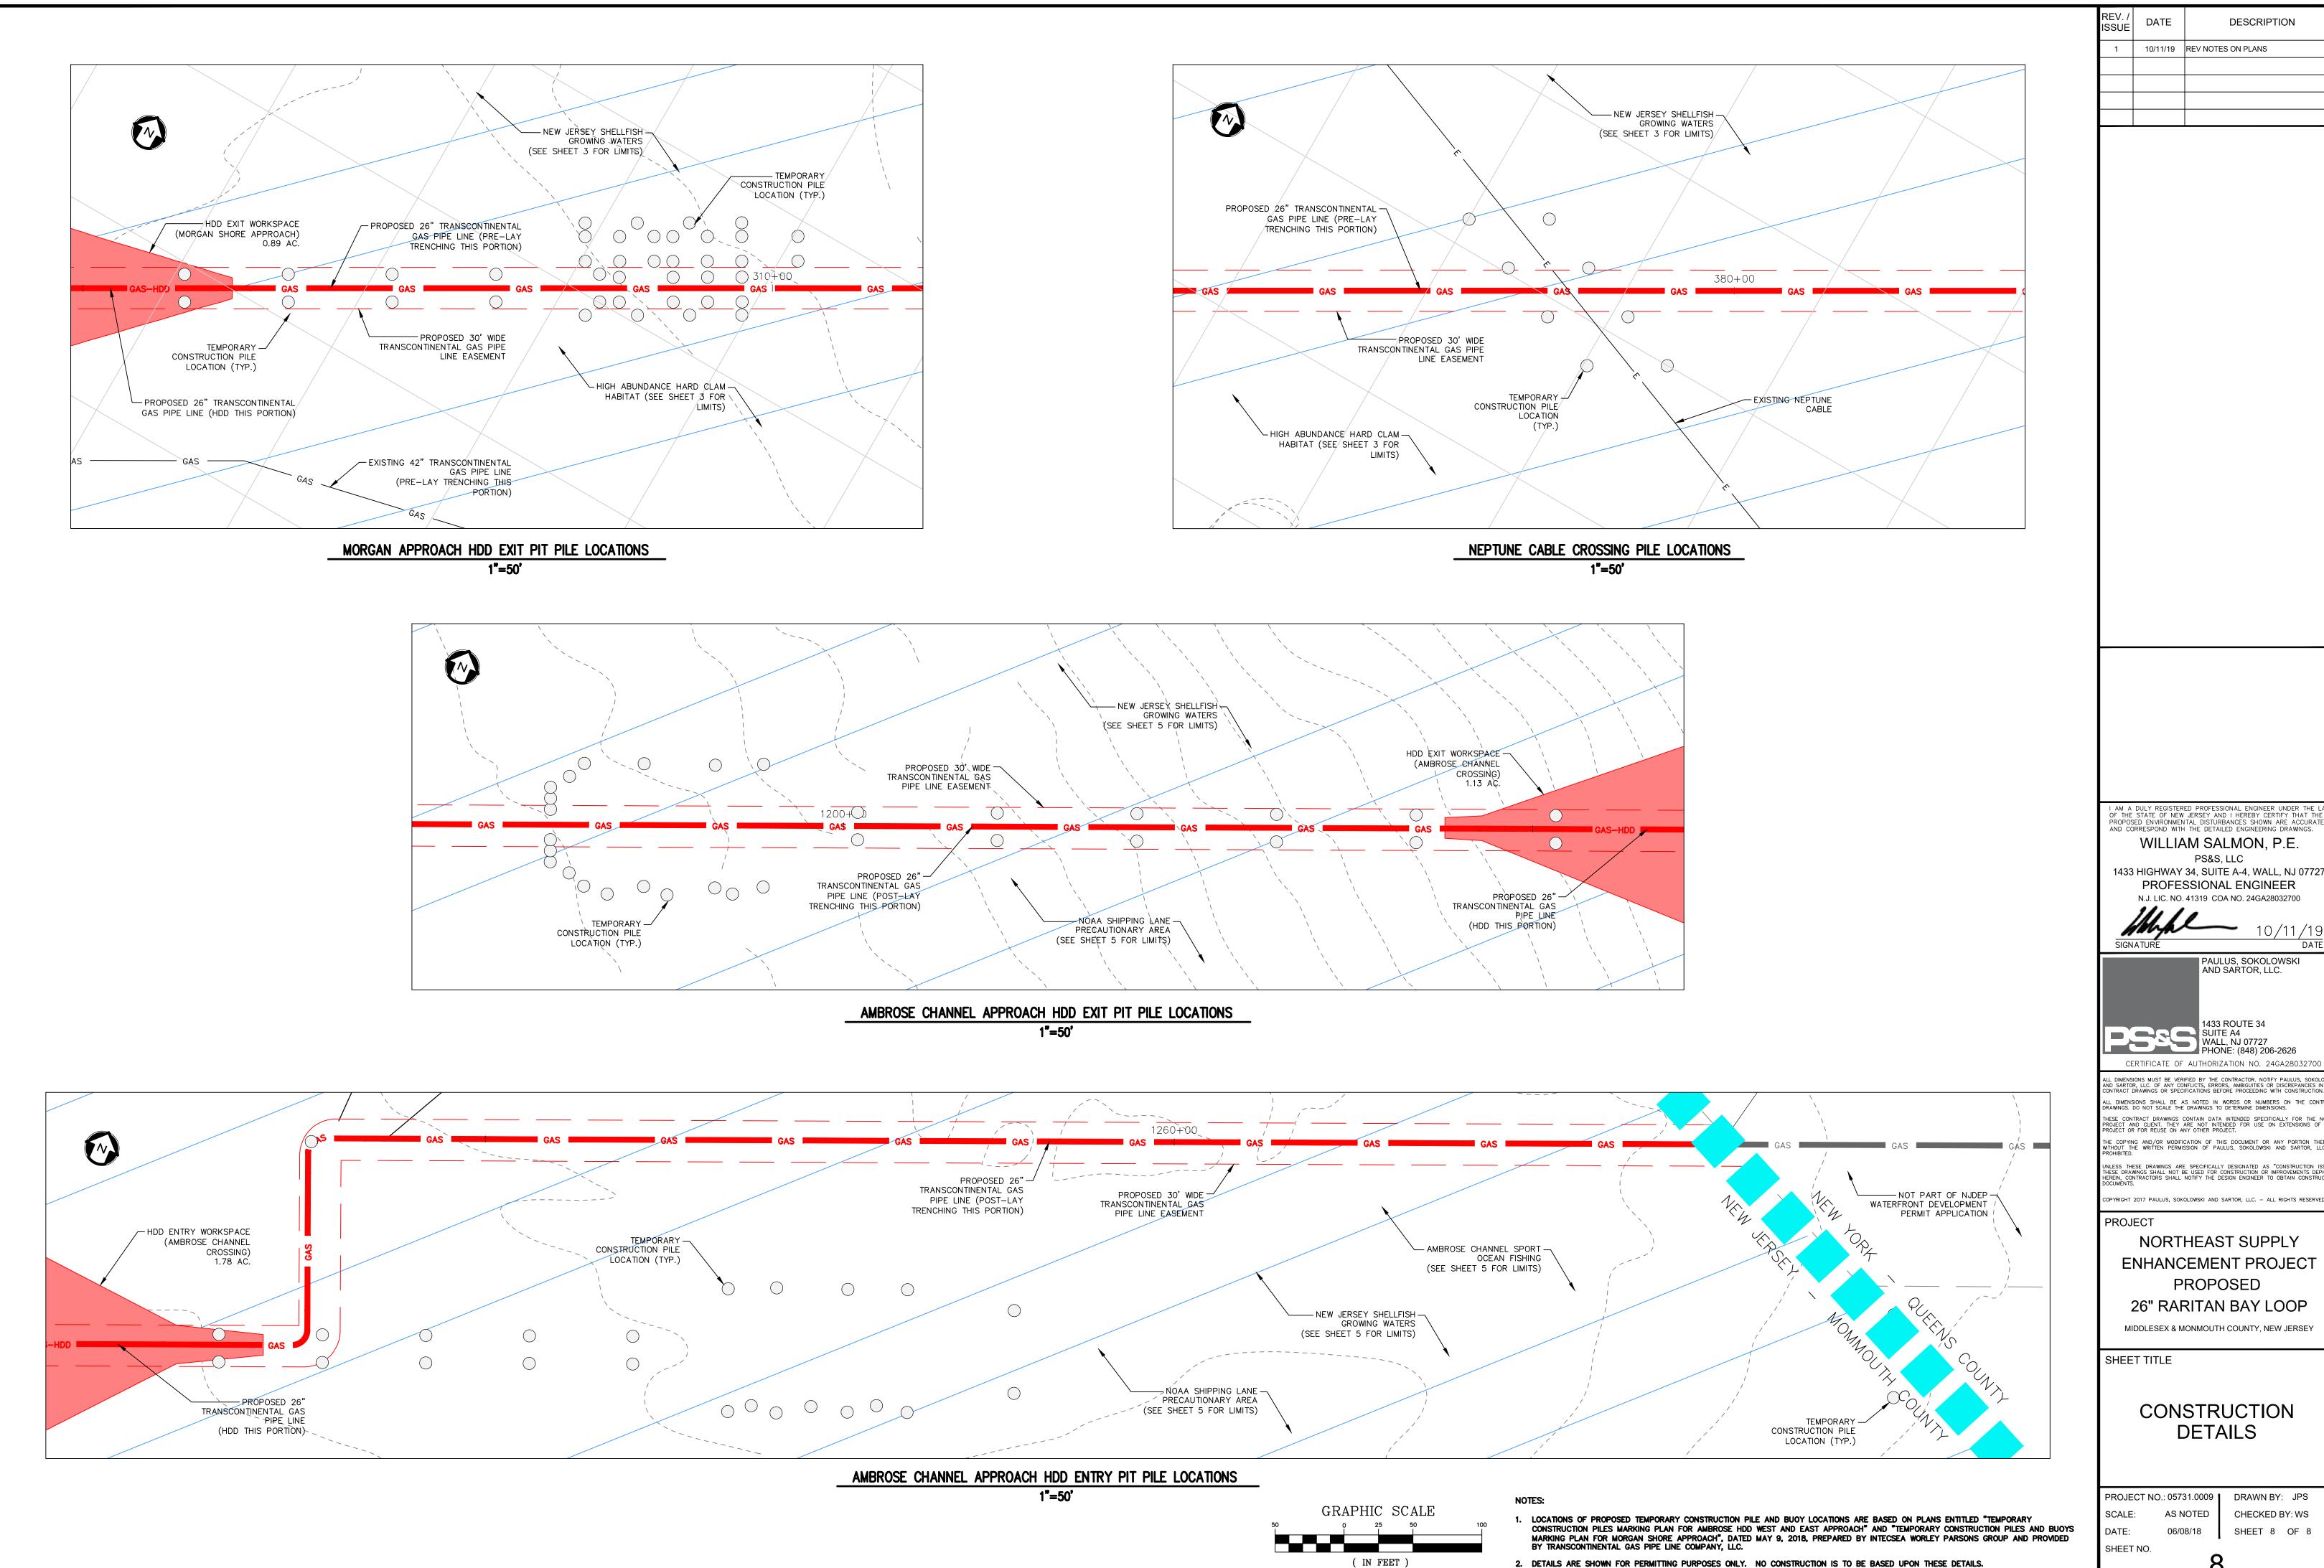

DESCRIPTION 10/11/19 REV NOTES ON PLANS

I AM A DULY REGISTERED PROFESSIONAL ENGINEER UNDER THE LAV OF THE STATE OF NEW JERSEY AND I HEREBY CERTIFY THAT THE PROPOSED ENVIRONMENTAL DISTURBANCES SHOWN ARE ACCURATE WILLIAM SALMON, P.E.

PS&S, LLC 1433 HIGHWAY 34, SUITE A-4, WALL, NJ 07727 PROFESSIONAL ENGINEER N.J. LIC. NO. 41319 COA NO. 24GA28032700

PAULUS, SOKOLOWSKI AND SARTOR, LLC.

1433 ROUTE 34 PSSS 1433 ROUTE 34 SUITE A4 WALL, NJ 07727 PHONE: (848) 206-2626

THESE CONTRACT DRAWINGS CONTAIN DATA INTENDED SPECIFICALLY FOR THE NO' PROJECT AND CLIENT. THEY ARE NOT INTENDED FOR USE ON EXTENSIONS OF T PROJECT OR FOR REUSE ON ANY OTHER PROJECT. INLESS THESE DRAWINGS ARE SPECIFICALLY DESIGNATED AS "CONSTRUCTION ISSUMESS DRAWINGS SHALL NOT BE USED FOR CONSTRUCTION OR IMPROVEMENTS DEPICTEDED. TO OBTAIN CONSTRUCTION OR IMPROVEMENTS DEPICTEDED. TO OBTAIN CONSTRUCT OCUMENTS.

OPYRIGHT 2017 PAULUS, SOKOLOWSKI AND SARTOR, LLC. — ALL RIGHTS RESERVED.

PROJECT

NORTHEAST SUPPLY **ENHANCEMENT PROJECT** PROPOSED 26" RARITAN BAY LOOP

MIDDLESEX & MONMOUTH COUNTY, NEW JERSEY

CONSTRUCTION **DETAILS**

AS NOTED 06/08/18

2. DETAILS ARE SHOWN FOR PERMITTING PURPOSES ONLY. NO CONSTRUCTION IS TO BE BASED UPON THESE DETAILS.

1 inch = 50 ft.

CHECKED BY: WS SHEET 8 OF 8

8

